

BUILDING 500 EXTERIOR CANOPY SHELTER

HORRY-GEORGETOWN TECHNICAL COLLEGE
4003 SOUTH FRASER STREET
GEORGETOWN, SC 29440


SOUTH CAROLINA STATE PROJECT NUMBER
H59-N269-CB HGTC BLDG. 500 EXTERIOR RENOVATION



SYMBOLS LEGEND

DRAWING TITLE DRAWING I.D. NUMBER		DETAIL (ENLARGEMENT) DRAWING I.D. NUMBER	
1 FLOOR PLAN SCALE: 3/16" = 1'-0"		1 A13 AREA TO BE ENLARGED	
BUILDING SECTION DRAWING I.D. NUMBER SHEET NUMBER		1 A2.13	
WALL SECTION DRAWING I.D. NUMBER SHEET NUMBER		1 A1.22	
1 COLUMN REFERENCE NUMBER COLUMN CENTER LINE		A	
ELEVATION SECTION I.D. NUMBER SHEET NUMBER		ELEVATION HEIGHT LEVEL REFERENCE LEVEL ELEVATION HEIGHT	
1 A1.22		00'-00"	
REVISIONS ADDENDUM NUMBER REVISED AREA		ROOM NUMBER ROOM NAME VESTIBULE ROOM NUMBER SQUARE FOOTAGE	
1		100	
CEILING HEIGHT CEILING HEIGHT ABOVE FINISHED FLOOR		DOOR NUMBER DOOR NUMBER DESIGNATION	
6'-6"		1	
KEYED NOTES KEYED NOTE DESIGNATION		WINDOW NUMBER WINDOW NUMBER DESIGNATION	
1		A	
FINISH MATERIAL FINISH DESIGNATION, TRIM ONLY COMMENTS, IF APPLICABLE		NORTH ARROW TRUE PROJECT NORTH	
P-1		N	
INTERIOR ELEVATION TAG ELEVATION NOTATION		TOILET ACCESSORIES ACCESSORY NUMBER DESIGNATION	
1 A3.33		12	
EQUIPMENT NUMBER DIRECTION OF ELEVATION REFERENCE DRAWING NUMBER		EQUIPMENT NUMBER ACCESSORY NUMBER DESIGNATION	
1 A3.33		AH-12	
FIRE EXTINGUISHER WALL HUNG		WITH CABINET	
1		1	

VICINITY MAP

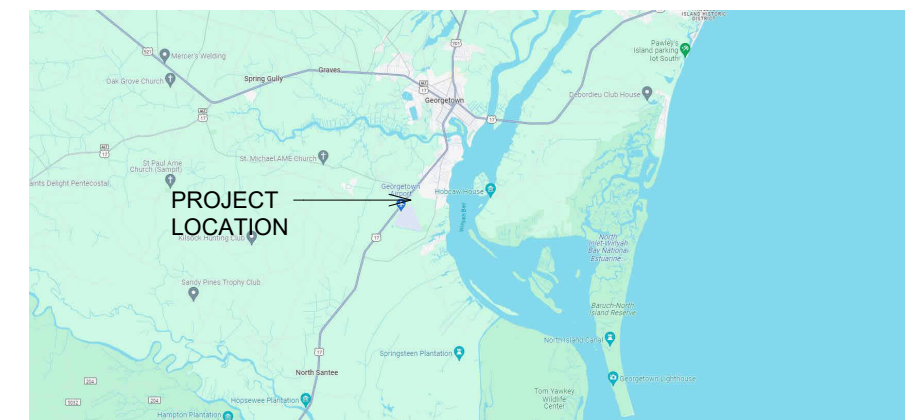

CONTACT LIST

OWNERS
CLIENT NAME: DIANNA CECALA / KEVIN BROWN
ORGANIZATION NAME: HORRY-GEORGETOWN TECH COLLEGE, BUILDING 500
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 CONSTRUCTION DOCUMENTS APPROVAL
 STRUCTURAL DESIGN APPROVAL
 M-E-P DESIGN APPROVAL

ACCEPTANCE BY:

1st Owner: _____
Date: _____
2nd Owner: _____
Date: _____

BUILDING CODES UTILIZED

2021 INTERNATIONAL BUILDING CODE
2021 INTERNATIONAL EXISTING BUILDING CODE
2021 INTERNATIONAL MECHANICAL CODE
2021 INTERNATIONAL FIRE CODE
2021 INTERNATIONAL PLUMBING CODE
2021 INTERNATIONAL FUEL GAS CODE
2021 NATIONAL ELECTRIC CODE
2021 INTERNATIONAL ENERGY CONSERVATION CODE
2021 ICC A117.1 ACCESSIBILITY CODE
NFPA STANDARDS
(AS ADOPTED BY THE OFFICE OF STATE FIRE MARSHAL)

ABBREVIATIONS

A.D.A.	AMERICANS WITH DISABILITIES ACT
A.F.F.	ABOVE FINISHED FLOOR
A/C	AIR CONDITIONING
ALUM.	ALUMINUM
BLDG.	BUILDING
C/C	CENTER TO CENTER
CL	CENTER LINE
CMU	CONCRETE MASONRY UNIT
D.F.	DRINKING FOUNTAIN
DIA.	DIAMETER
DWG.	DRAWING
E.I.F.S.	EXTERIOR INSULATION FINISH SYSTEM ELECTRICAL
ELEC.	ELECTRIC WATER COOLER
EWC	ELECTRIC WATER HEATER
EWH	FLOOR DRAIN
F.D.	FIRE EXTINGUISHER
F.F.	FINISH FLOOR
FIN.FLR.	GENERAL CONTRACTOR
G.C.	GALLONS PER HOUR
G.P.H.	GROUND FAULT INTERCEPT CIRCUIT
G.F.I.C.	GYP-SUM BOARD
GYP.BD.	HEATING VENTILATION AND AIR
HVAC	CONDITIONING
IBC	INTERNATIONAL BUILDING CODE
MFR.	MANUFACTURER
MIN.	MINIMUM
MTL.	METAL
N.I.C.	NOT IN CONTRACT
N.T.S.	NOT TO SCALE
N/A	NOT APPLICABLE
#	NUMBER
O.C.	ON CENTER
P.E.	PHOTO-ELECTRIC
PLBG.	PLUMBING
PLYWD.	PLYWOOD
PVC	POLY-VINYL CHLORIDE
R.D.	ROOF DRAIN
R.O.	ROUGH OPENING
R.R.	RESTROOM
RTU	ROOF TOP UNIT
S/S	STAINLESS STEEL
SPECS.	SPECIFICATIONS
SS	SANITARY SEWER
ST.	STORM DRAIN
TYP.	TYPICAL
U.L.	UNDERWRITERS LABORATORIES
U.L.O.	UNLESS NOTED OTHERWISE
V.C.T.	VINYL COMPOSITE TILE
VTR	VENT THROUGH ROOF
W.C.	WATER CLOSET
W.H.	WATER HEATER
W.	WITH
WC	WATER CLOSET

INDEX OF DRAWINGS

G1.01	PROJECT COVERSHEET
G1.02	SPECIAL INSPECTIONS
G1.03	LIFE SAFETY PLAN / CODE REVIEW
C1.01	EXISTING CONDITIONS
A1.01	EXISTING FLOOR PLAN
A1.02	PROPOSED FLOOR PLAN
A1.03	PROPOSED FOUNDATION PLAN
A1.04	PROPOSED ROOF PLAN
A2.01	EXISTING EXTERIOR ELEVATIONS
A2.02	PROPOSED EXTERIOR ELEVATIONS
A3.01	BUILDING SECTIONS
A3.02	BUILDING SECTIONS
A6.01	DOOR SCHEDULE & DETAILS
P1.01	PLUMBING PLAN
E1.01	ELECTRICAL PLAN
S1.01	FOUNDATION PLAN
S2.01	STRUCTURAL DETAILS
S3.01	STRUCTURAL NOTES

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STATEMENT OF SPECIAL INSTRUCTIONS

Table with columns: Inspection Description, IBC 2018 Section, IMIT, Required: (yes / no), Extent: (periodic or continuous), Agent, Completed. Lists various construction items like Special Cases, Cold Formed Steel Deck, Reinforced Concrete, etc.

DEFINITIONS:

- #1) SPECIAL INSPECTOR: PER IBC "A QUALIFIED PERSON EMPLOYED OR RETAINED BY AN APPROVED AGENCY AND APPROVED BY THE BUILDING OFFICIAL AS HAVING THE COMPETENCE NECESSARY TO INSPECT A PARTICULAR TYPE OF CONSTRUCTION REQUIRING SPECIAL INSPECTION".

ALUMINUM:

WHERE ALUMINUM IS PLACED IN CONTACT WITH DISSIMILAR MATERIALS, THE ALUMINUM SHALL BE PROTECTED AGAINST CORROSION OR BACK-PAINTED BEFORE ERECTION WITH ZINC CHROMATE PAINT.

WINDOWS/ STOREFRONT/ GLASS SYSTEMS :

- 1) ALL MEMBERS PART OF GLASS SYSTEMS SHALL BE SECURELY ANCHORED TO THE STRUCTURAL SYSTEM(S) AS DETAILED BY THE MANUFACTURER AND/OR IN THE STOREFRONT/GLASS SHOP DRAWINGS.

STATEMENT OF SPECIAL INSPECTIONS FOR STRUCTURAL COMPONENTS (PER CHAPTER 17, 2021 IBC)

Table with columns: BUILDING SYSTEM OR COMPONENT, MATERIAL SUBMITTAL, TESTING (REQUIREMENTS, FREQUENCY, AGENCY), INSPECTION (PER IBC) (MONITORING, FREQUENCY, AGENCY), QUALITY ASSURANCE (PER IBC) (PART OF WIND, PART OF SEISMIC). Includes rows for SOILS, CONCRETE FOUNDATIONS, STRUCTURAL STEEL, etc.

NOTE: ALL TESTING, INSPECTION & RELATED REPORTS SHALL BE SENT TO THE SPECIAL INSPECTION COORDINATOR & THE OWNER. ANY DEFICIENCIES SHALL BE CLEARLY NOTED & BROUGHT TO THE ATTENTION OF THE SPECIAL INSPECTION COORDINATOR BEFORE THE END OF THE INSPECTOR'S SHIFT.

SEISMIC QUALITY ASSURANCE PLAN

- 1. THE FOLLOWING SEISMIC SYSTEMS AND SEISMIC-FORCE-RESISTING SYSTEM ARE SUBJECT TO QUALITY ASSURANCE: A. MASONRY SHEARWALL REINFORCEMENT.

CONTRACTOR'S RESPONSIBILITY

- EACH CONTRACTOR RESPONSIBLE FOR THE CONSTRUCTION OF A SEISMIC - FORCE -RESISTING SYSTEM, DESIGNATED SEISMIC SYSTEM, OR A COMPONENT LISTED IN THE SEISMIC QUALITY ASSURANCE PLAN SHALL SUBMIT A WRITTEN CONTRACTOR'S STATEMENT OF RESPONSIBILITY TO THE BUILDING OFFICIAL AND TO THE OWNER PRIOR TO THE COMMENCEMENT OF WORK ON THE SYSTEM OR COMPONENT.


WIND QUALITY ASSURANCE PLAN

- 1. THE FOLLOWING MAIN WIND FORCE-RESISTING SYSTEMS AND WIND RESISTING COMPONENTS ARE SUBJECT TO QUALITY ASSURANCE: A. MASONRY SHEARWALL CONSTRUCTION AND REINFORCEMENT.

CONTRACTOR'S RESPONSIBILITY

- EACH CONTRACTOR RESPONSIBLE FOR THE CONSTRUCTION OF A SEISMIC - FORCE -RESISTING SYSTEM, DESIGNATED SEISMIC SYSTEM, OR A COMPONENT LISTED IN THE SEISMIC QUALITY ASSURANCE PLAN SHALL SUBMIT A WRITTEN CONTRACTOR'S STATEMENT OF RESPONSIBILITY TO THE BUILDING OFFICIAL AND TO THE OWNER PRIOR TO THE COMMENCEMENT OF WORK ON THE SYSTEM OR COMPONENT.

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REVISION SCHEDULE table with columns: NO., DATE, DESCRIPTION. Shows 12 revisions.

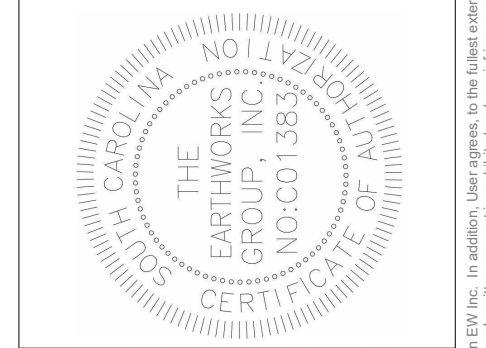BUILDING 500 EXTERIOR CANOPY SHELTER. HENRY-GEORGETOWN TECHNICAL COLLEGE. SPECIAL INSPECTIONS. PREPARED FOR: HENRY-GEORGETOWN TECHNICAL COLLEGE. DESIGNED BY: SS. DRAWN BY: RP. CHECKED BY: SS.

G1.02



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2021 South Carolina Building Code Data			
GENERAL INFORMATION			
Project Name: BLDG 500 Extension	Address: 4003 SOUTH FRASER STREET, GEORGETOWN SC 29440		
Owner's Name: Horry Georgetown Technical College	Address: 2050 HWY 501 EAST CONWAY, SC 29526		
Building Code Dept: Horry County Code Enforcement, 1301 Second Avenue, Conway, SC 29526			
Project Description: 2110 SQFT. OUTDOOR CANOPY SPACE FOR BOAT / FIBERGLASS REPAIR			
CHAPTER-3 ASSEMBLY GROUP "B"			
CHAPTER-5 GENERAL BLDG. HGT. & AREAS			
Floor (Use):	Allowable Area (Table #506.2) Frontage Increase (Para. #506.3) Total Allowable Area (per Floor) Actual Area (per Floor)		
1st Floor:	9,000 sq.ft. N/A 9,000 sq.ft. 2,110 sq.ft.		
2nd Floor:	N/A N/A N/A N/A		
Allowable Height (Para. #504.3): "ASSEMBLY GROUP B" Occupancy, Non-Sprinkled, UnProtected: 40'-0" (Actual: <25'-0")			
Allowable Stories (Para. #504.4): "ASSEMBLY GROUP B" Occupancy, Non-Sprinkled, UnProtected: 2 stories (Actual: 1)			
Mixed Use (508.1): N/A			
Accessory use Areas (508.2): N/A			
Non-Separated Occupancies (508.3): N/A			
Separated Occupancies (508.4): N/A			
Incidental Use Areas (Table 509): N/A			
CHAPTER-6 TYPE OF CONSTRUCTION			
Para. #602: Type 2B			
Fire Resistance Rating / Table #601:			
Structural Frame:	Ext. Bearing Wall: Int. Bearing Wall: Floor Construction: Roof Construction:		
0 hr.	0 hr. 0 hr. 0 hr. 0 hr.		
Fire Resistance Rating of Exterior Wall / Table #602: > 30' = 0 hr.			
CHAPTER-7 FIRE RATED CONSTRUCTION			
Maximum Exterior Wall Opening / Table #705.8:			
Separation Distance:	North >30'-0" East >30'-0" South >30'-0" West >30'-0"		
Maximum Opening %:	UL N/A N/A UL UL		
Shaft Enclosures (Section 707.3.1): N/A			
Fire Partitions (Para. 708.1): Under #708.3 "Exceptions", If Sprinkled; Corridor & Sleeping Unit walls can be 1/2 h. Fire Rated			
CHAPTER-9 FIRE PROTECTION			
Full Fire Suppression System (903.2): Use Group "B". Not Required <12,000 sqft. <300 Occupants @ Ground Level Standpipe System (905.4): Not Required: < 30' above finish grade.			
Fire Extinguishers (906.1): Yes as required by the International Fire Code (10-b Rating at < 30 Travel Distance)			
Fire Alarm Detection system (907.2.2): Not Required			
Automatic Smoke Detection System (907.2.8.1): Not Required			
CHAPTER-10 MEANS OF EGRESS			
Design Occupant Load / Table 1004.1:			
RM #	Occupant/SF	Actual SF	# Occupants
Office:103	150 gross	1055 (min) sq.ft.	7
Total: 7			
Required Egress Width / Table #1005.1:		Doorways: 0.2" per Occupant (Refer to Life Safety Plan for concurrence)	
# of Exits Table #1006.2.1: Spaces < 49 & <100' Egress Travel Distance = 2.			
Required Exit Separation Para. #1007.1.1: A minimum of 1/2 the Diagonal distance.			
Egress Illumination #1008.3.2: Exit Doors, Corridors, Vestibules & Exterior Landings			
Elevator #1009.2.1 & 1009.4: No Elevators			
Panic Hardware #1010.1.10: Not Required in B Occupancy <50 Occupants			
Exit Stairway Width #1011.2: N/A			
Maximum Egress Travel Distance / Table #1017.2: N/A No Corridors			
Corridor Fire Rating Table #1020.1: N/A No Corridors			
CHAPTER-11 A.D.A.		Toilet Room & Bathing Requirements (1109.2.): At least (1) one of each Pibg. Fixture & Dispenser	
		Family Toilet Requirements (1110.2.1): N/A	
CHAPTER-29 PLUMBING SYSTEMS			
Requirement:		Calculation:	
Toilets:	Male: 1/25 Female: 1/25	1 PER 25 OCCUPANTS	ALL SHALL MEET ADA REQUIREMENTS
Lavatories:	Male: 1/25 Female: 1/25	1 PER 25 OCCUPANTS	ALL SHALL MEET ADA REQUIREMENTS
Baths/Shower:	N/A	N/A	N/A
Drinking Fountains/100	23 Occupants/100		
Service Sink:	1	=1	1 Unit shall meet ADA requirements
Lavatories: Note - Refer to Life Safety Plan for Location of Restrooms			

LIFE SAFETY LEGEND	
ITEM	DESCRIPTION
	STARTING POSITION OF PERSON EGRESSING SPACE
	EMERGENCY LIGHT / EXIT SIGN
	EMERGENCY LIGHT / EXIT SIGN
	FIRE EXTINGUISHER
	SMOKE DETECTOR
	EXIT DOOR SYMBOL
	CLEAR DOOR WIDTH
	DOOR'S EXIT CAPACITY
	DOOR'S EXIT REQUIREMENT
	PANIC DEVICE REQUIRED
	DISTANCE
	PATH OF TRAVEL
	EXTERIOR EGRESS LIGHT



1 LEVEL 1 FLOOR PLAN
SCALE 1/8" = 1'-0"

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PROJECT #	DATE	SCALE	DESIGNED BY	DRAWN BY	CHECKED BY
241006	05/13/2024	AS NOTED	SS	RP	SS

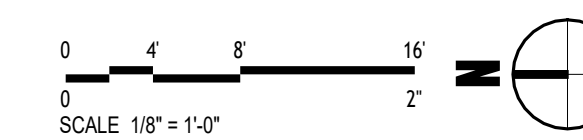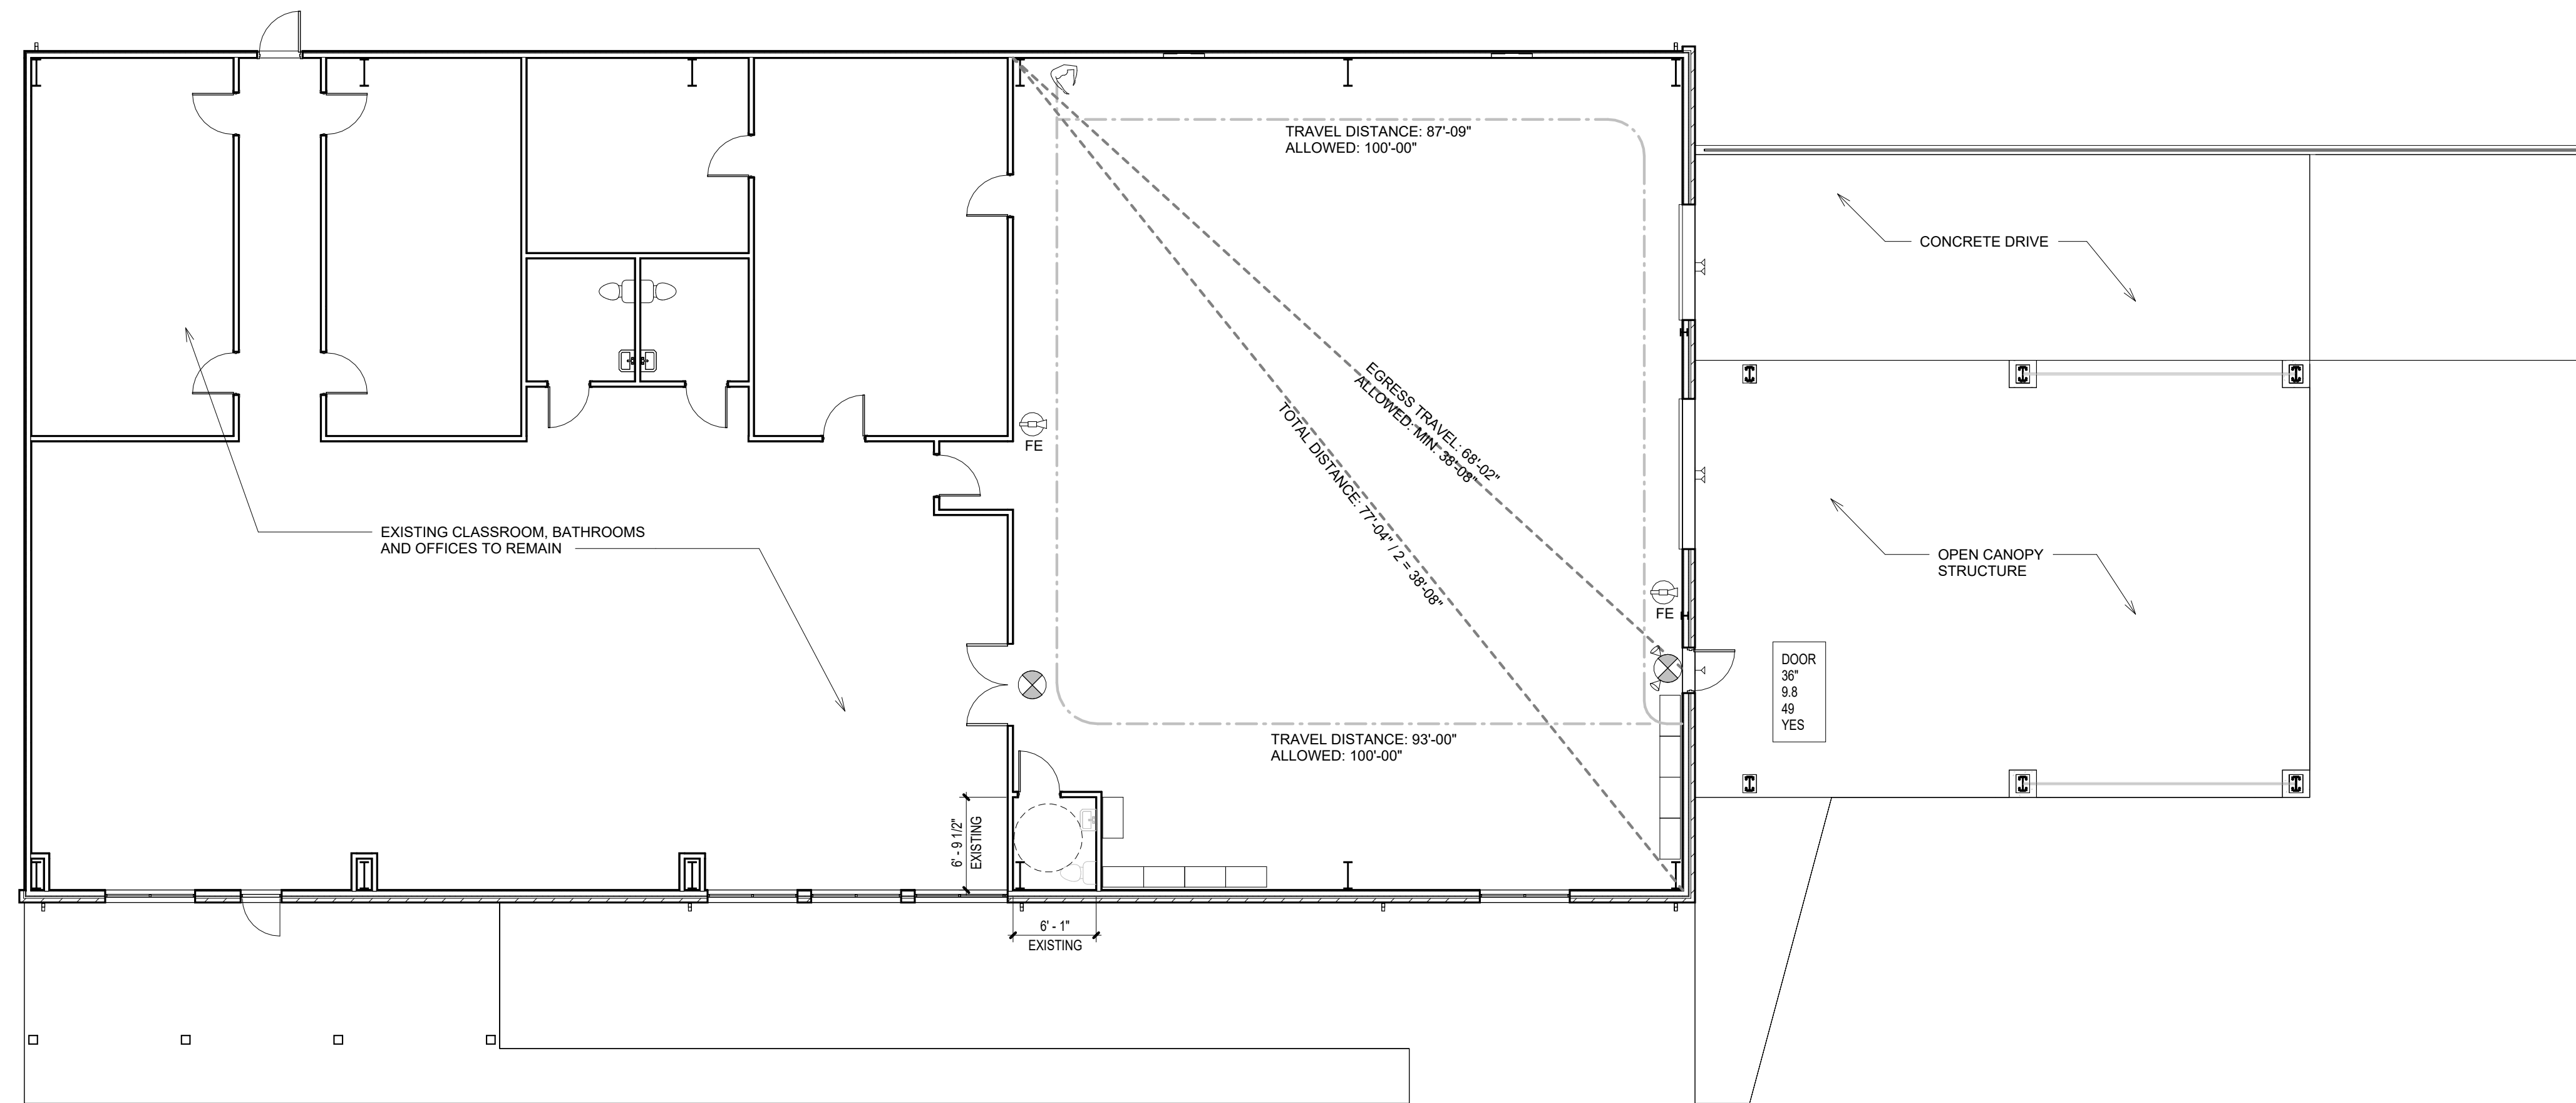BUILDING 500 EXTERIOR CANOPY SHELTER

Horry-Georgetown Technical College
4003 SOUTH FRASER STREET
GEORGETOWN, SC 29440

LIFE SAFETY PLAN / CODE REVIEW

PREPARED FOR:
Horry-Georgetown Technical College

NOT BIDDING

REVISION SCHEDULE

PROJECT # 241006

DATE 05/13/2024

SCALE AS NOTED


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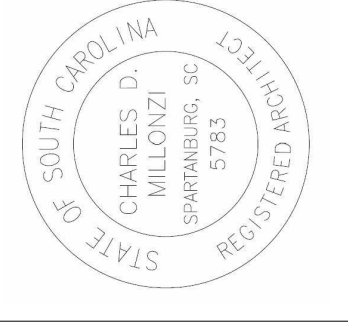
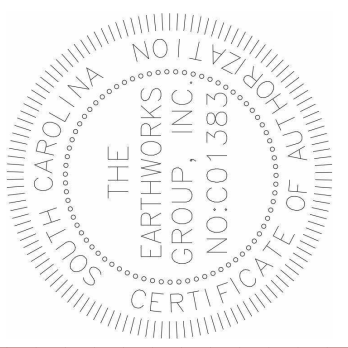
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BUILDING 500 EXTERIOR CANOPY SHELTER
 HENRY-GEORGETOWN TECHNICAL COLLEGE
 608 SOUTH MAIN STREET
 GEORGETOWN, SC 29526

EXISTING CONDITIONS

PREPARED FOR:
HORRY-GEORGETOWN TECHNICAL COLLEGE
 BOB BILBING

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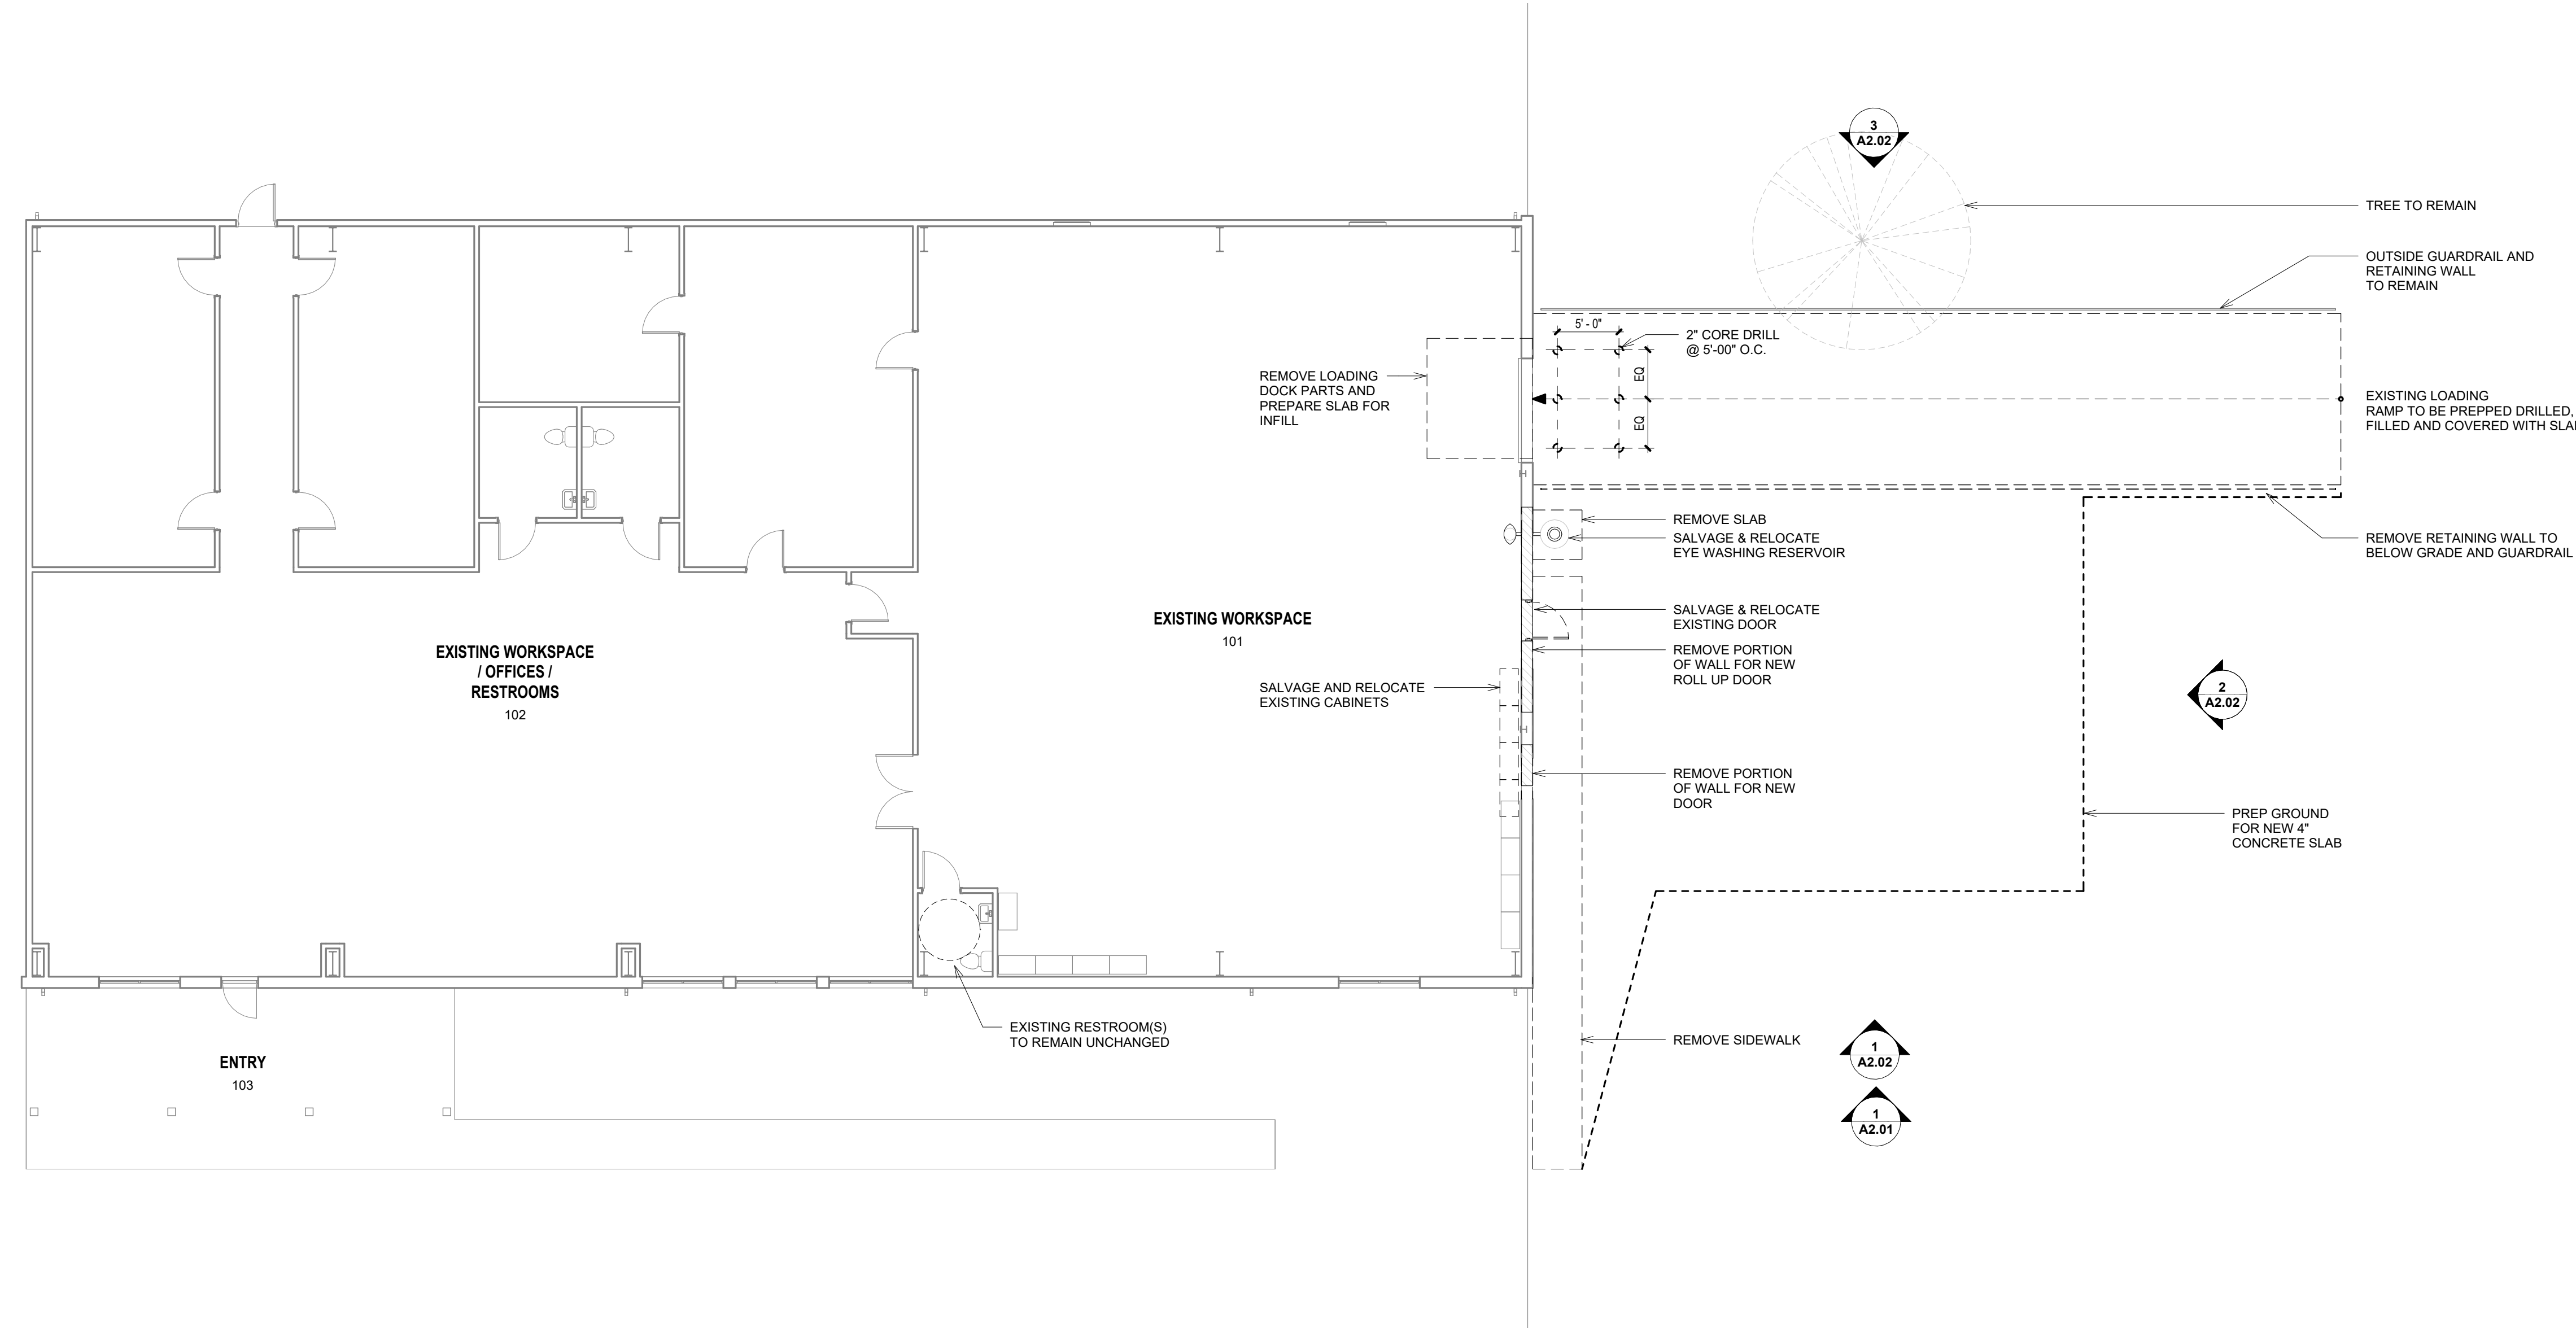
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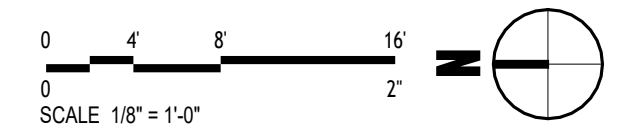
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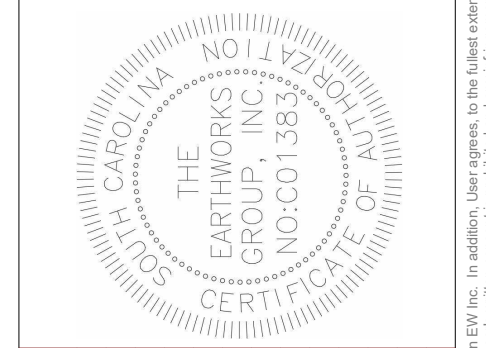
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1 LEVEL 1 FLOOR PLAN
SCALE 1/8" = 1'-0"

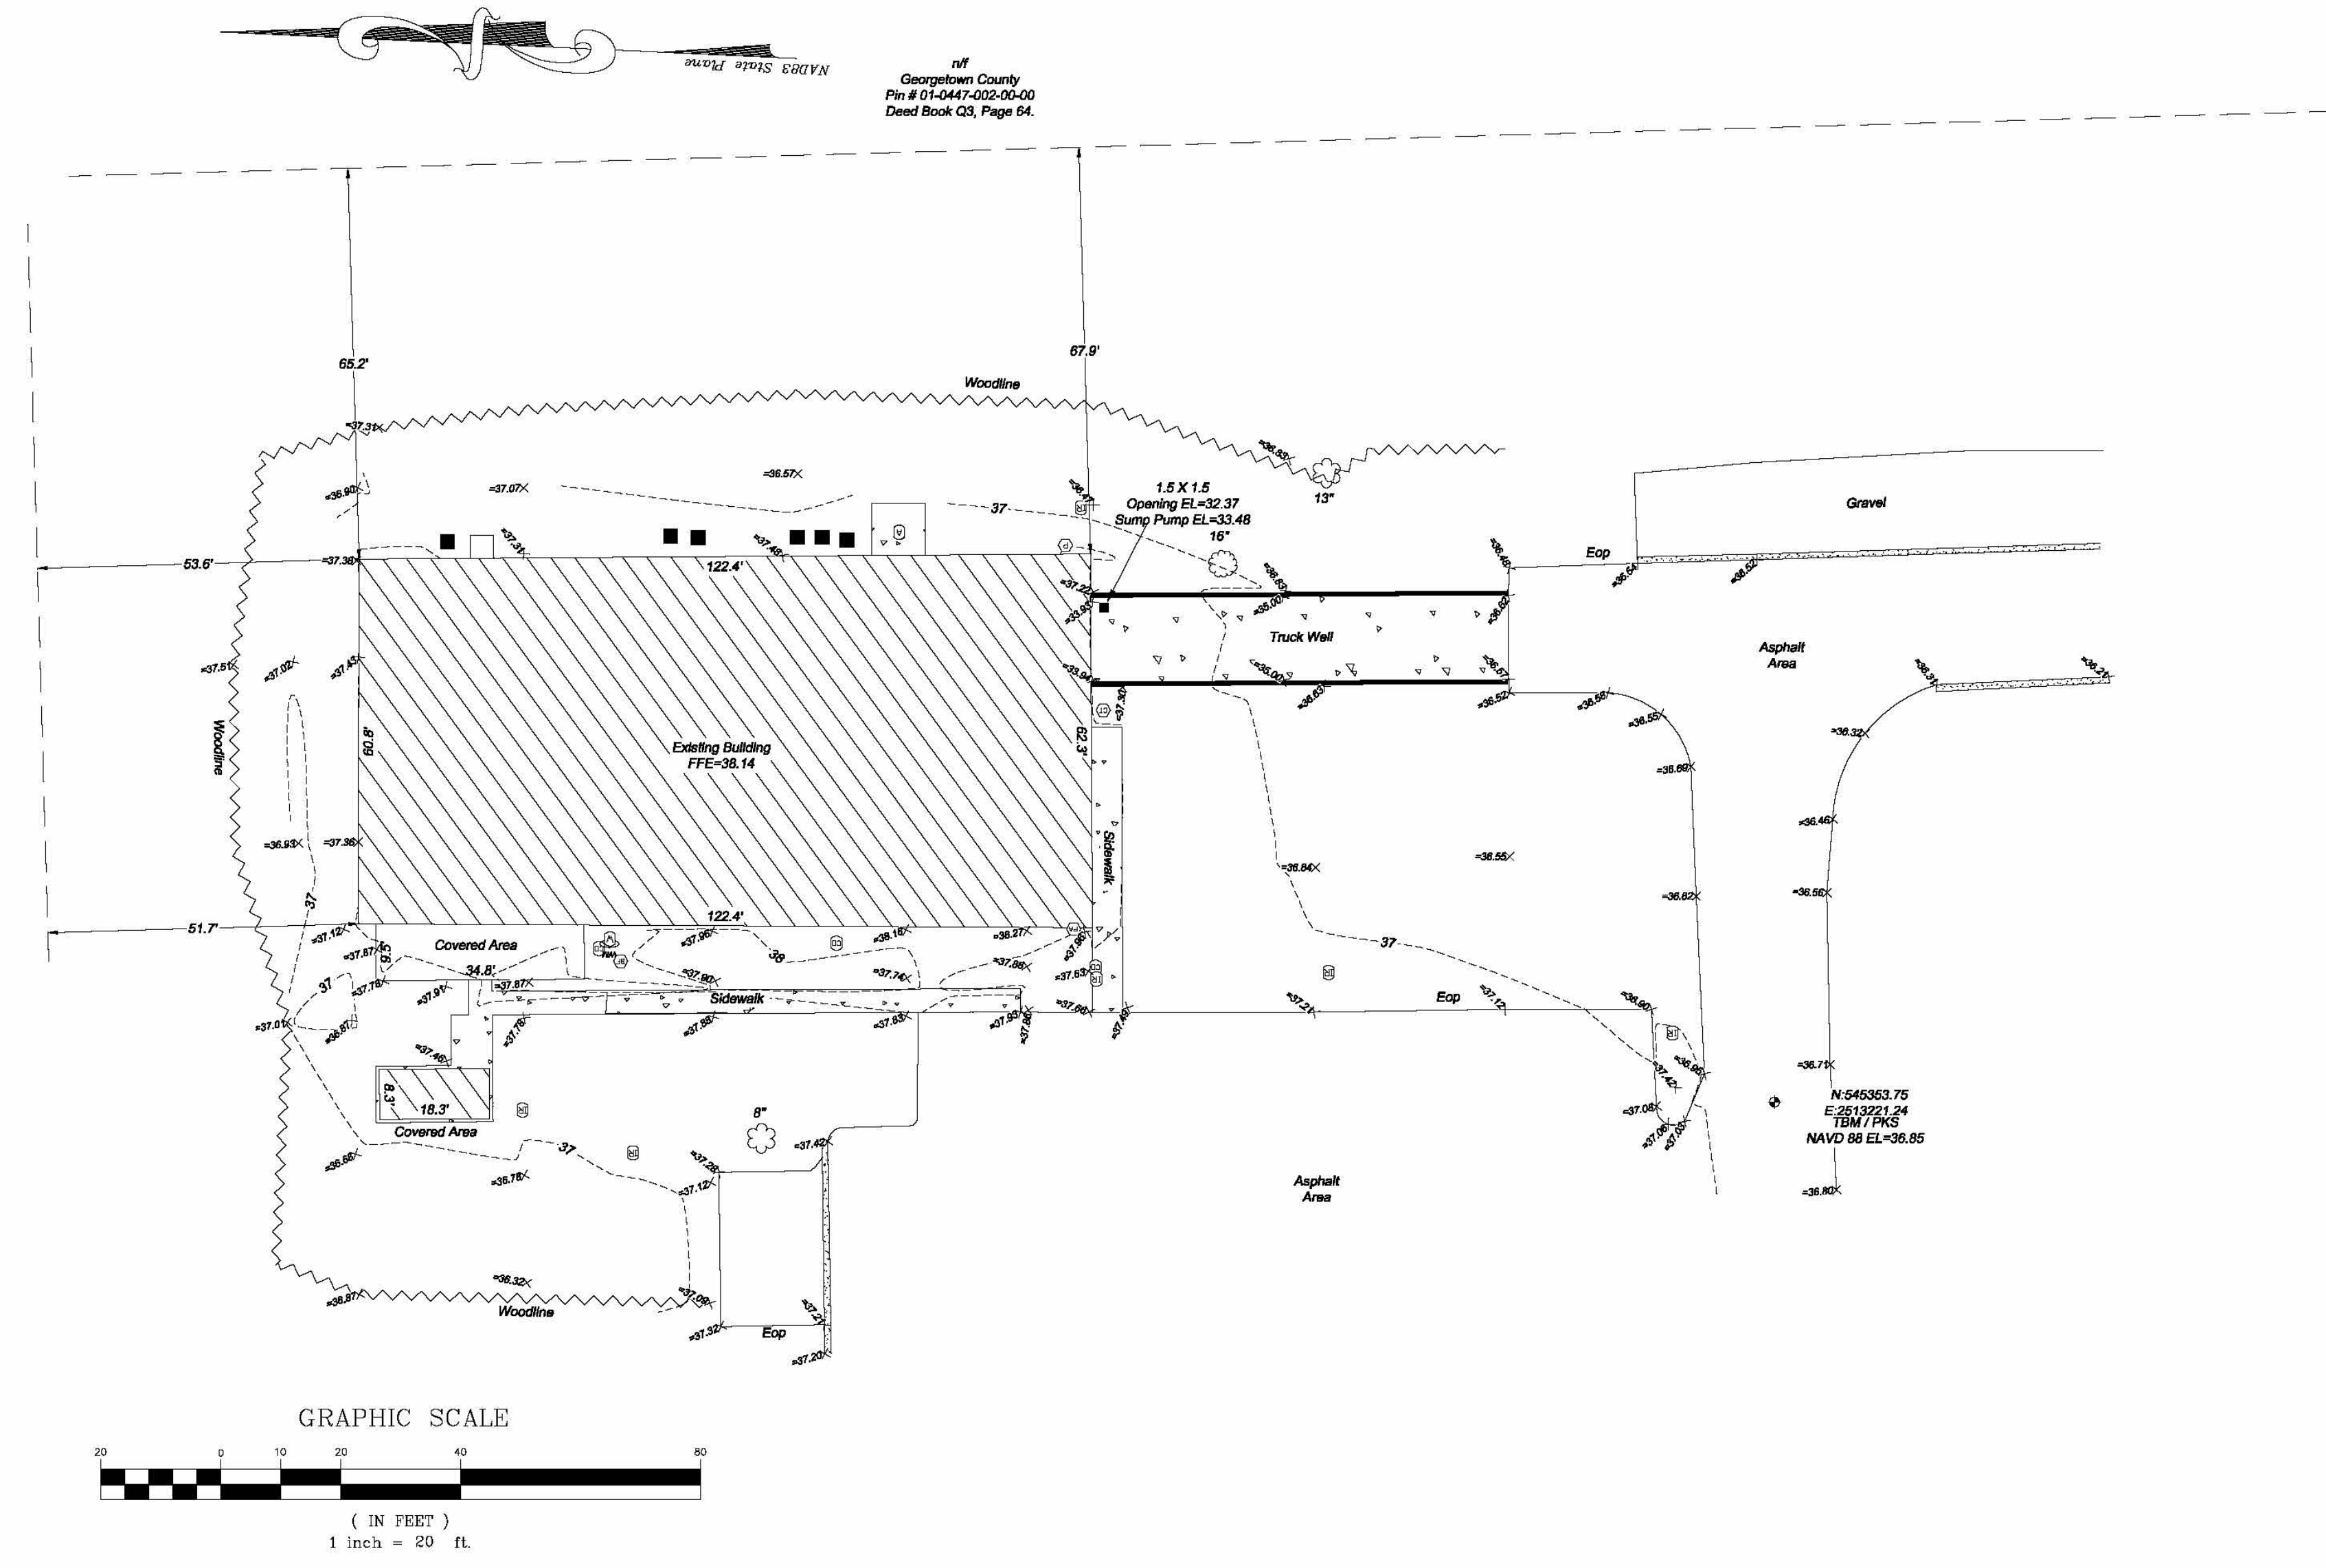

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BUILDING 500 EXTERIOR CANOPY SHELTER
HORRY-GEORGETOWN TECHNICAL COLLEGE
6008 SOUTH WINDYBROOK STREET
MURRELLS INLET, SC 29576
EXISTING FLOOR PLAN
PREPARED FOR:
HORRY-GEORGETOWN TECHNICAL COLLEGE
RKH/BELING


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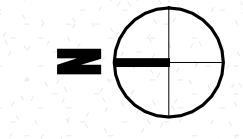
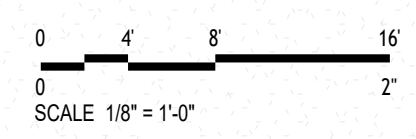
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1 LEVEL 1 FLOOR PLAN
SCALE 1/4" = 1'-0"




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BUILDING 500 EXTERIOR CANOPY SHELTER
 HENRY GEORGETOWN TECHNICAL COLLEGE
 608 SOUTH MAIN STREET
 GEORGETOWN, SC 29526

PROPOSED FLOOR PLAN

PREPARED FOR:
HORRY-GEORGETOWN TECHNICAL COLLEGE
 BLDG BUILDING
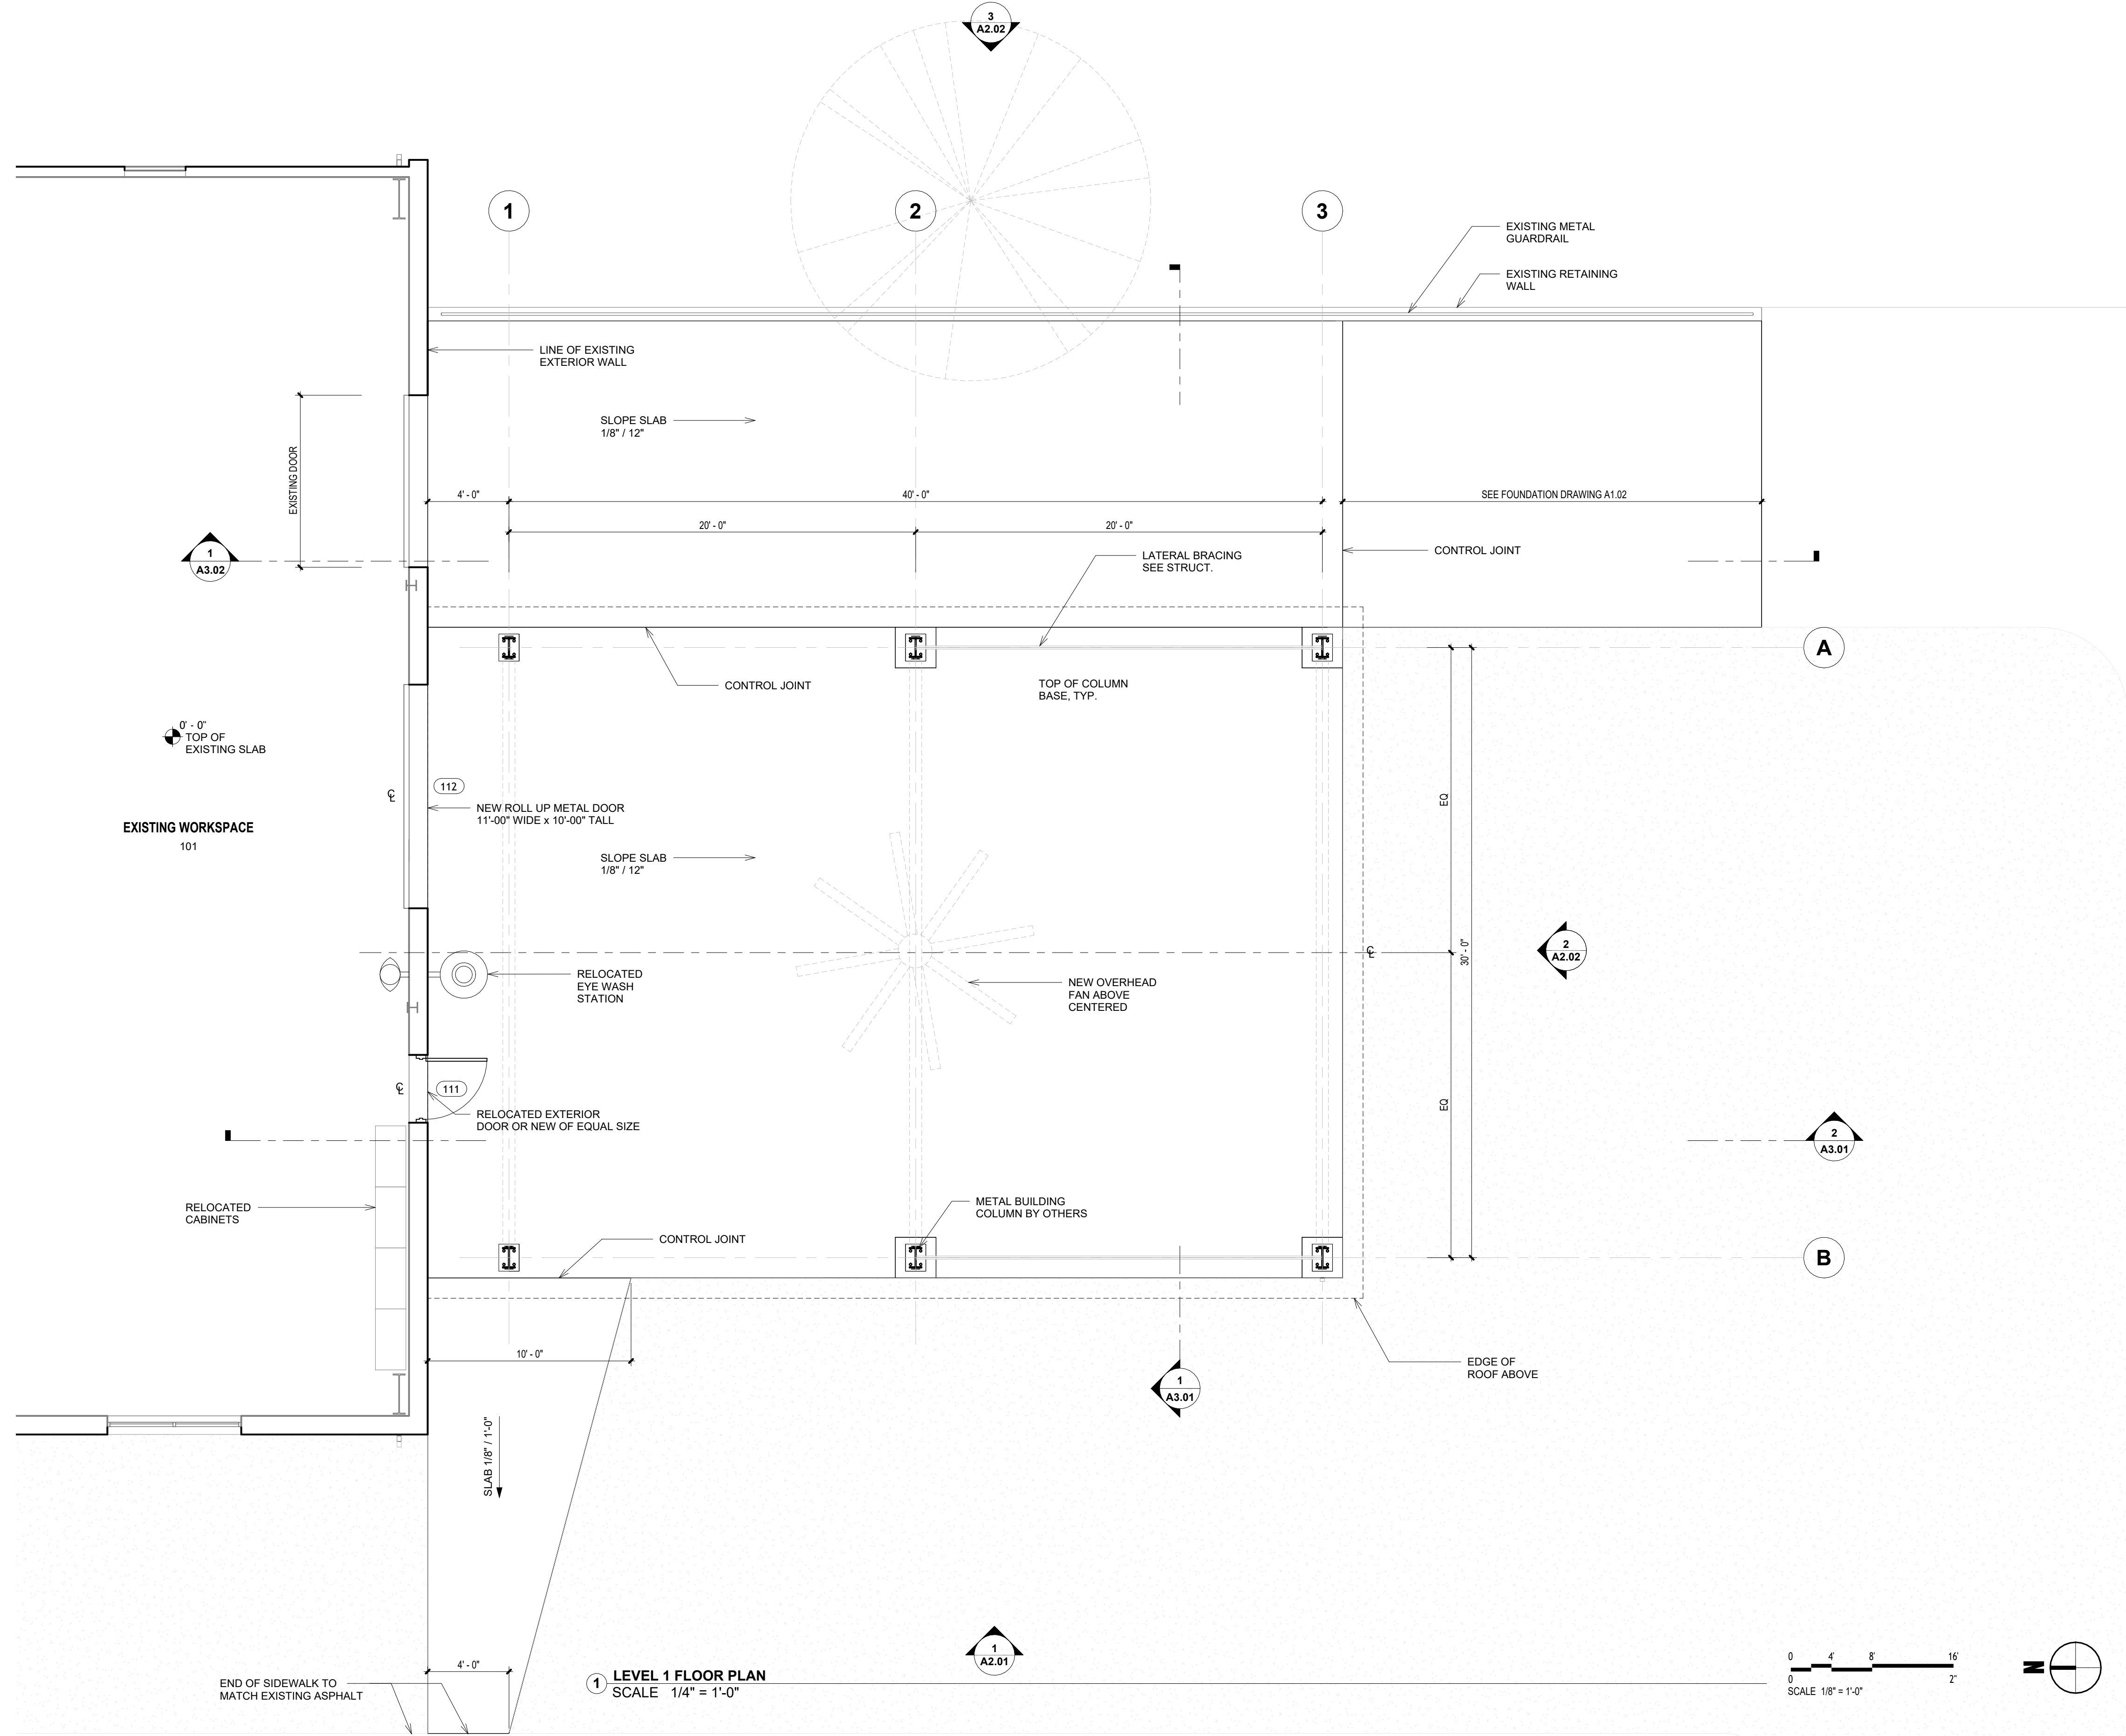
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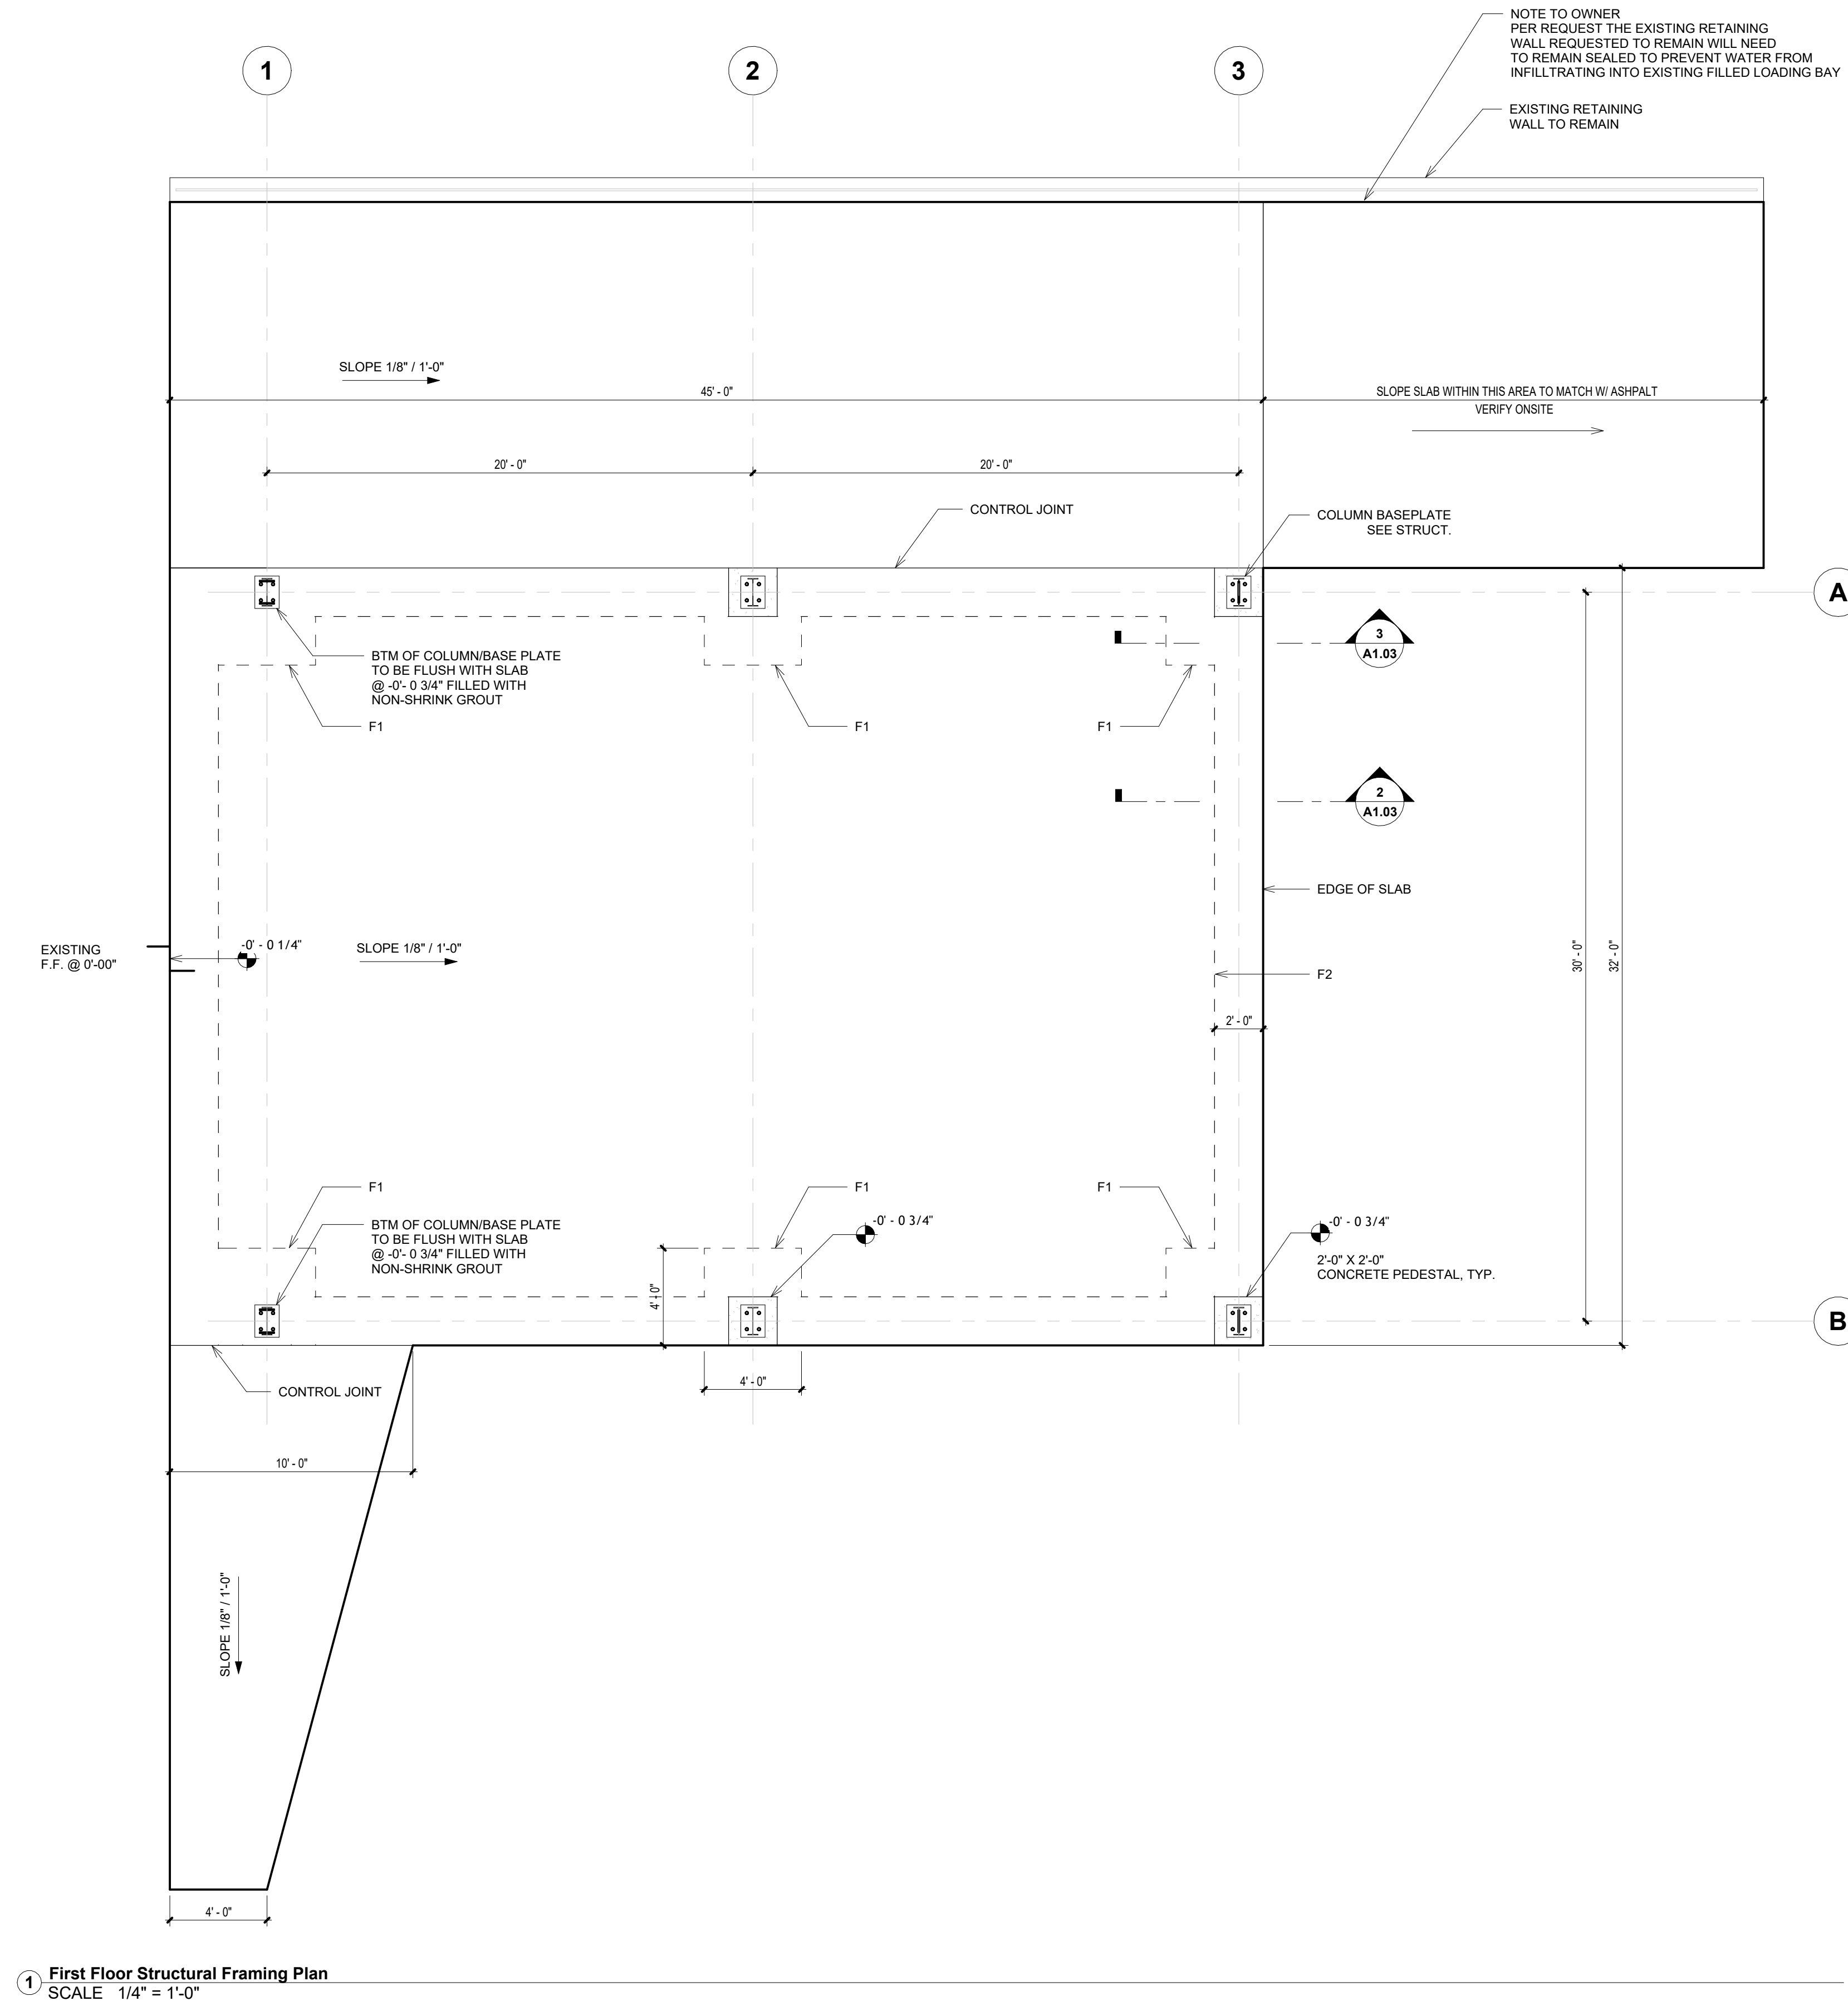
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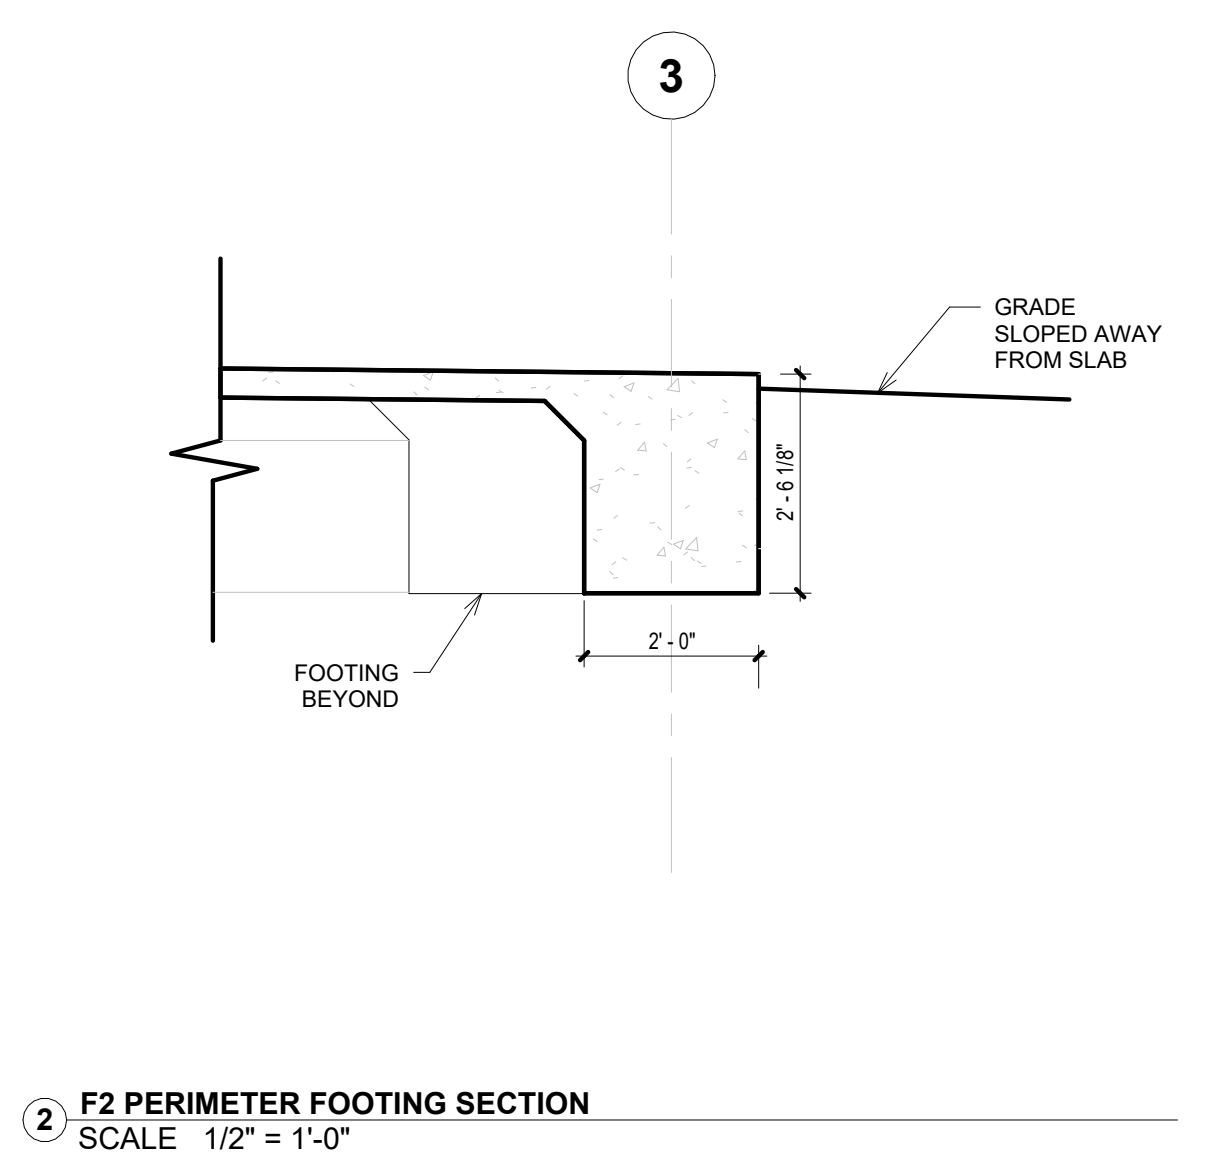
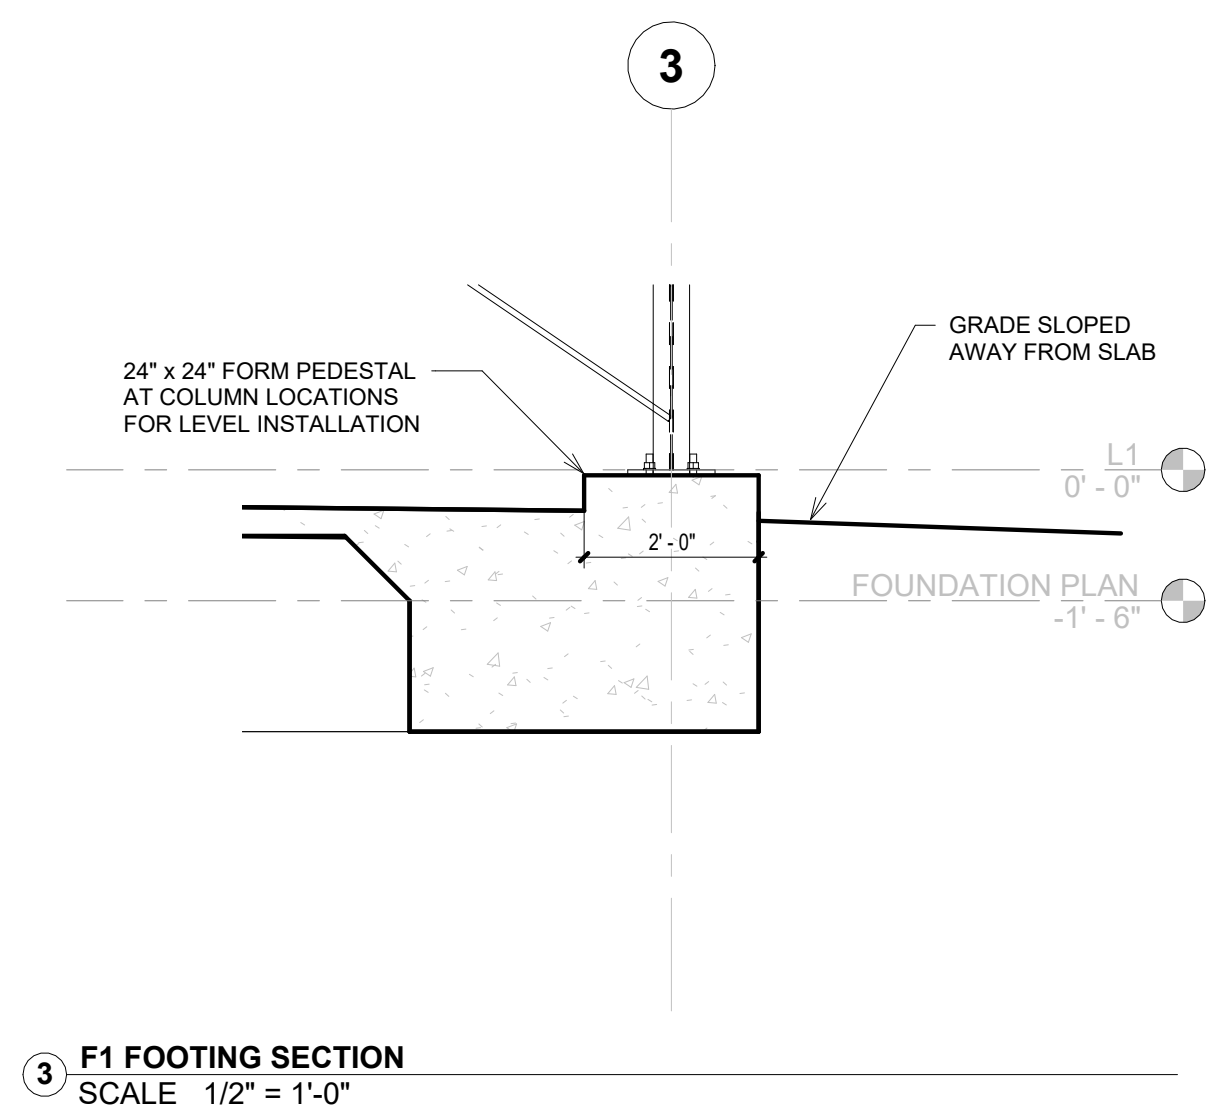
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1 First Floor Structural Framing Plan
SCALE 1/4" = 1'-0"

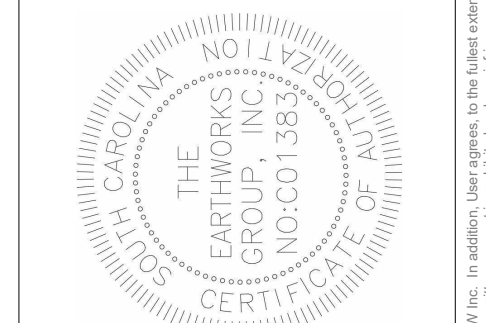

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(FAX) 843.651.7903
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STATE OF SOUTH CAROLINA
CHARLES D. MILLONZI
SPARTANBURG, SC 29163
REGISTERED

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NOC00136727
CERTIFICATE OF AUTHORITY

REVISION SCHEDULE	
NO.	DESCRIPTION
1	BY: [] DATE: []
2	BY: [] DATE: []
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11	BY: [] DATE: []
12	BY: [] DATE: []

BUILDING 500 EXTERIOR CANOPY SHELTER
HENRY GEORGETOWN TECHNICAL COLLEGE
600 SOUTH MAIN STREET
GEORGETOWN, SC 29522

PROPOSED FOUNDATION PLAN

PREPARED FOR:
HARRY GEORGETOWN TECHNICAL COLLEGE

PROJECT #: 241006
DATE: 05/13/2024
SCALE: AS NOTED
DESIGNED BY: SS
DRAWN BY: RP
CHECKED BY: SS


A1.03

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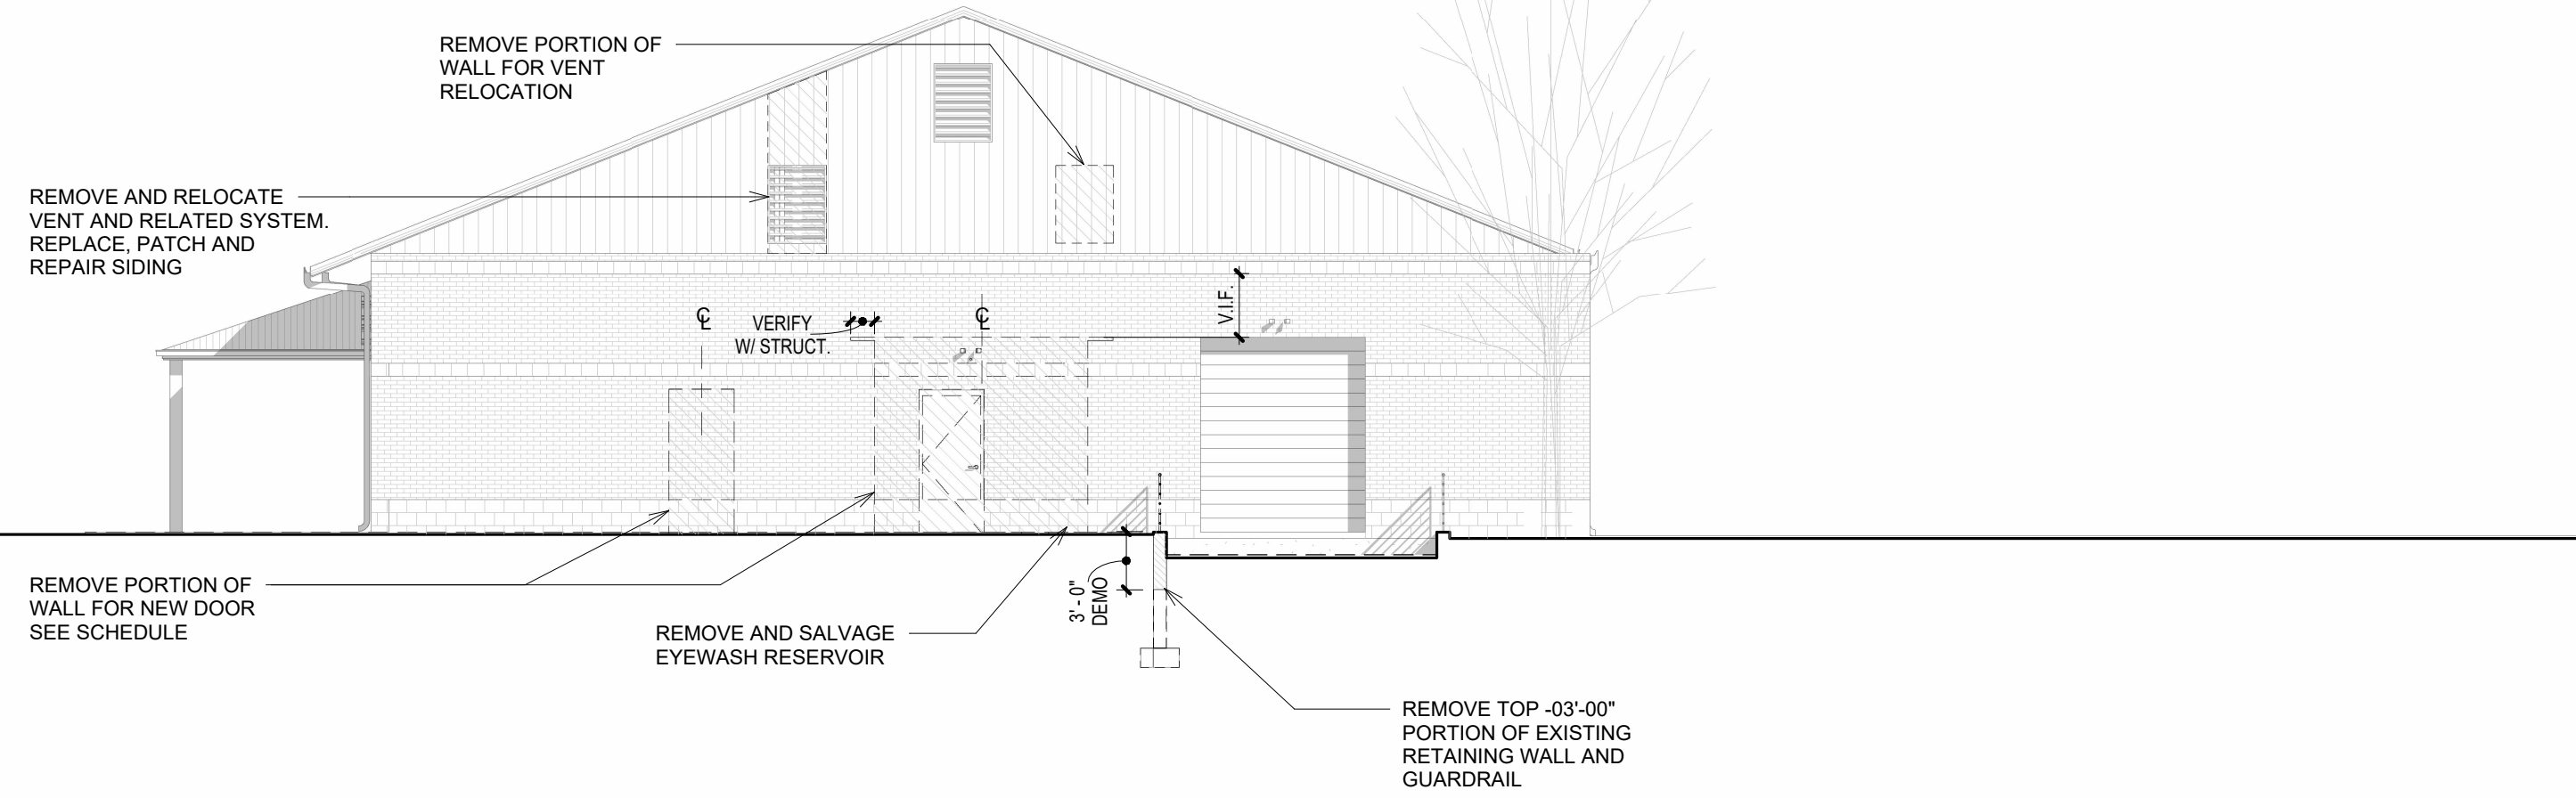
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1 SOUTH ELEVATION
SCALE 1/8" = 1'-0"



2 EAST ELEVATION
SCALE 1/8" = 1'-0"

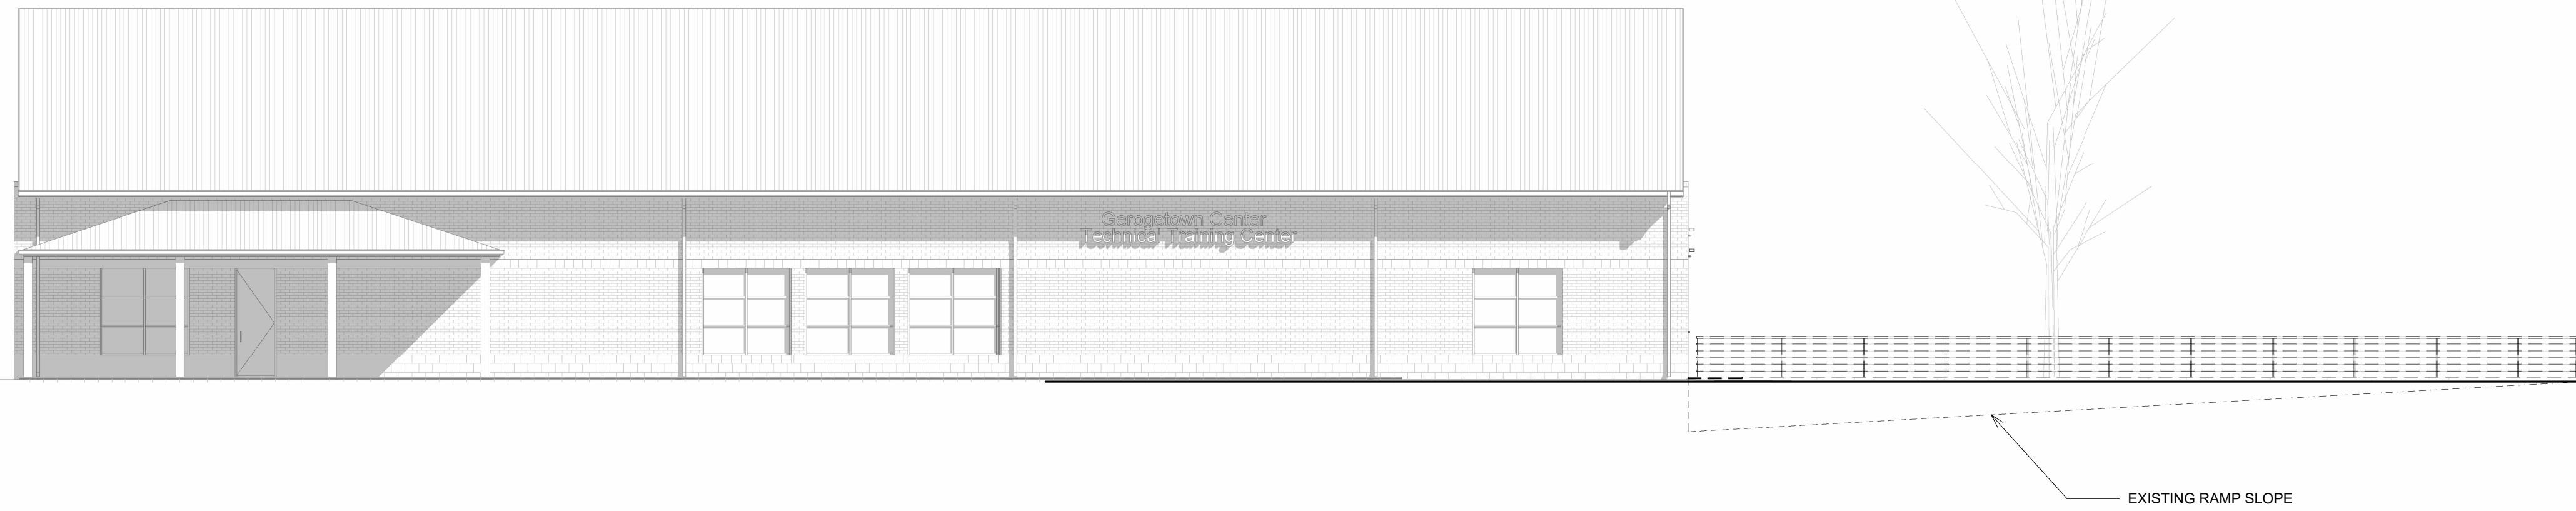



EXTERIOR MATERIAL LEGEND	
	1 - BRICK / STONEWORK
	2 - CORRUGATED METAL SIDING
	3 - BRICK / STONEWORK SOLDIER COURSE
	4 - BRICK / STONEWORK SOLDIER COURSE
	5 - ROLL UP METAL DOORS

A2.01

PROJECT #	241006
DATE	05/13/2024
SCALE	AS NOTED
DESIGNED BY:	SS
DRAWN BY:	RP
CHECKED BY:	SS
BUILDING 500 EXTERIOR CANOPY SHELTER	
HENRY GEORGETOWN TECHNICAL COLLEGE 600 SOUTH MAIN ST. SUITE 100 GEORGETOWN, SC 29526	
EXISTING EXTERIOR ELEVATIONS	
PREPARED FOR: HORRY-GEORGETOWN TECHNICAL COLLEGE	
BIM BUILDING	

REVISION SCHEDULE

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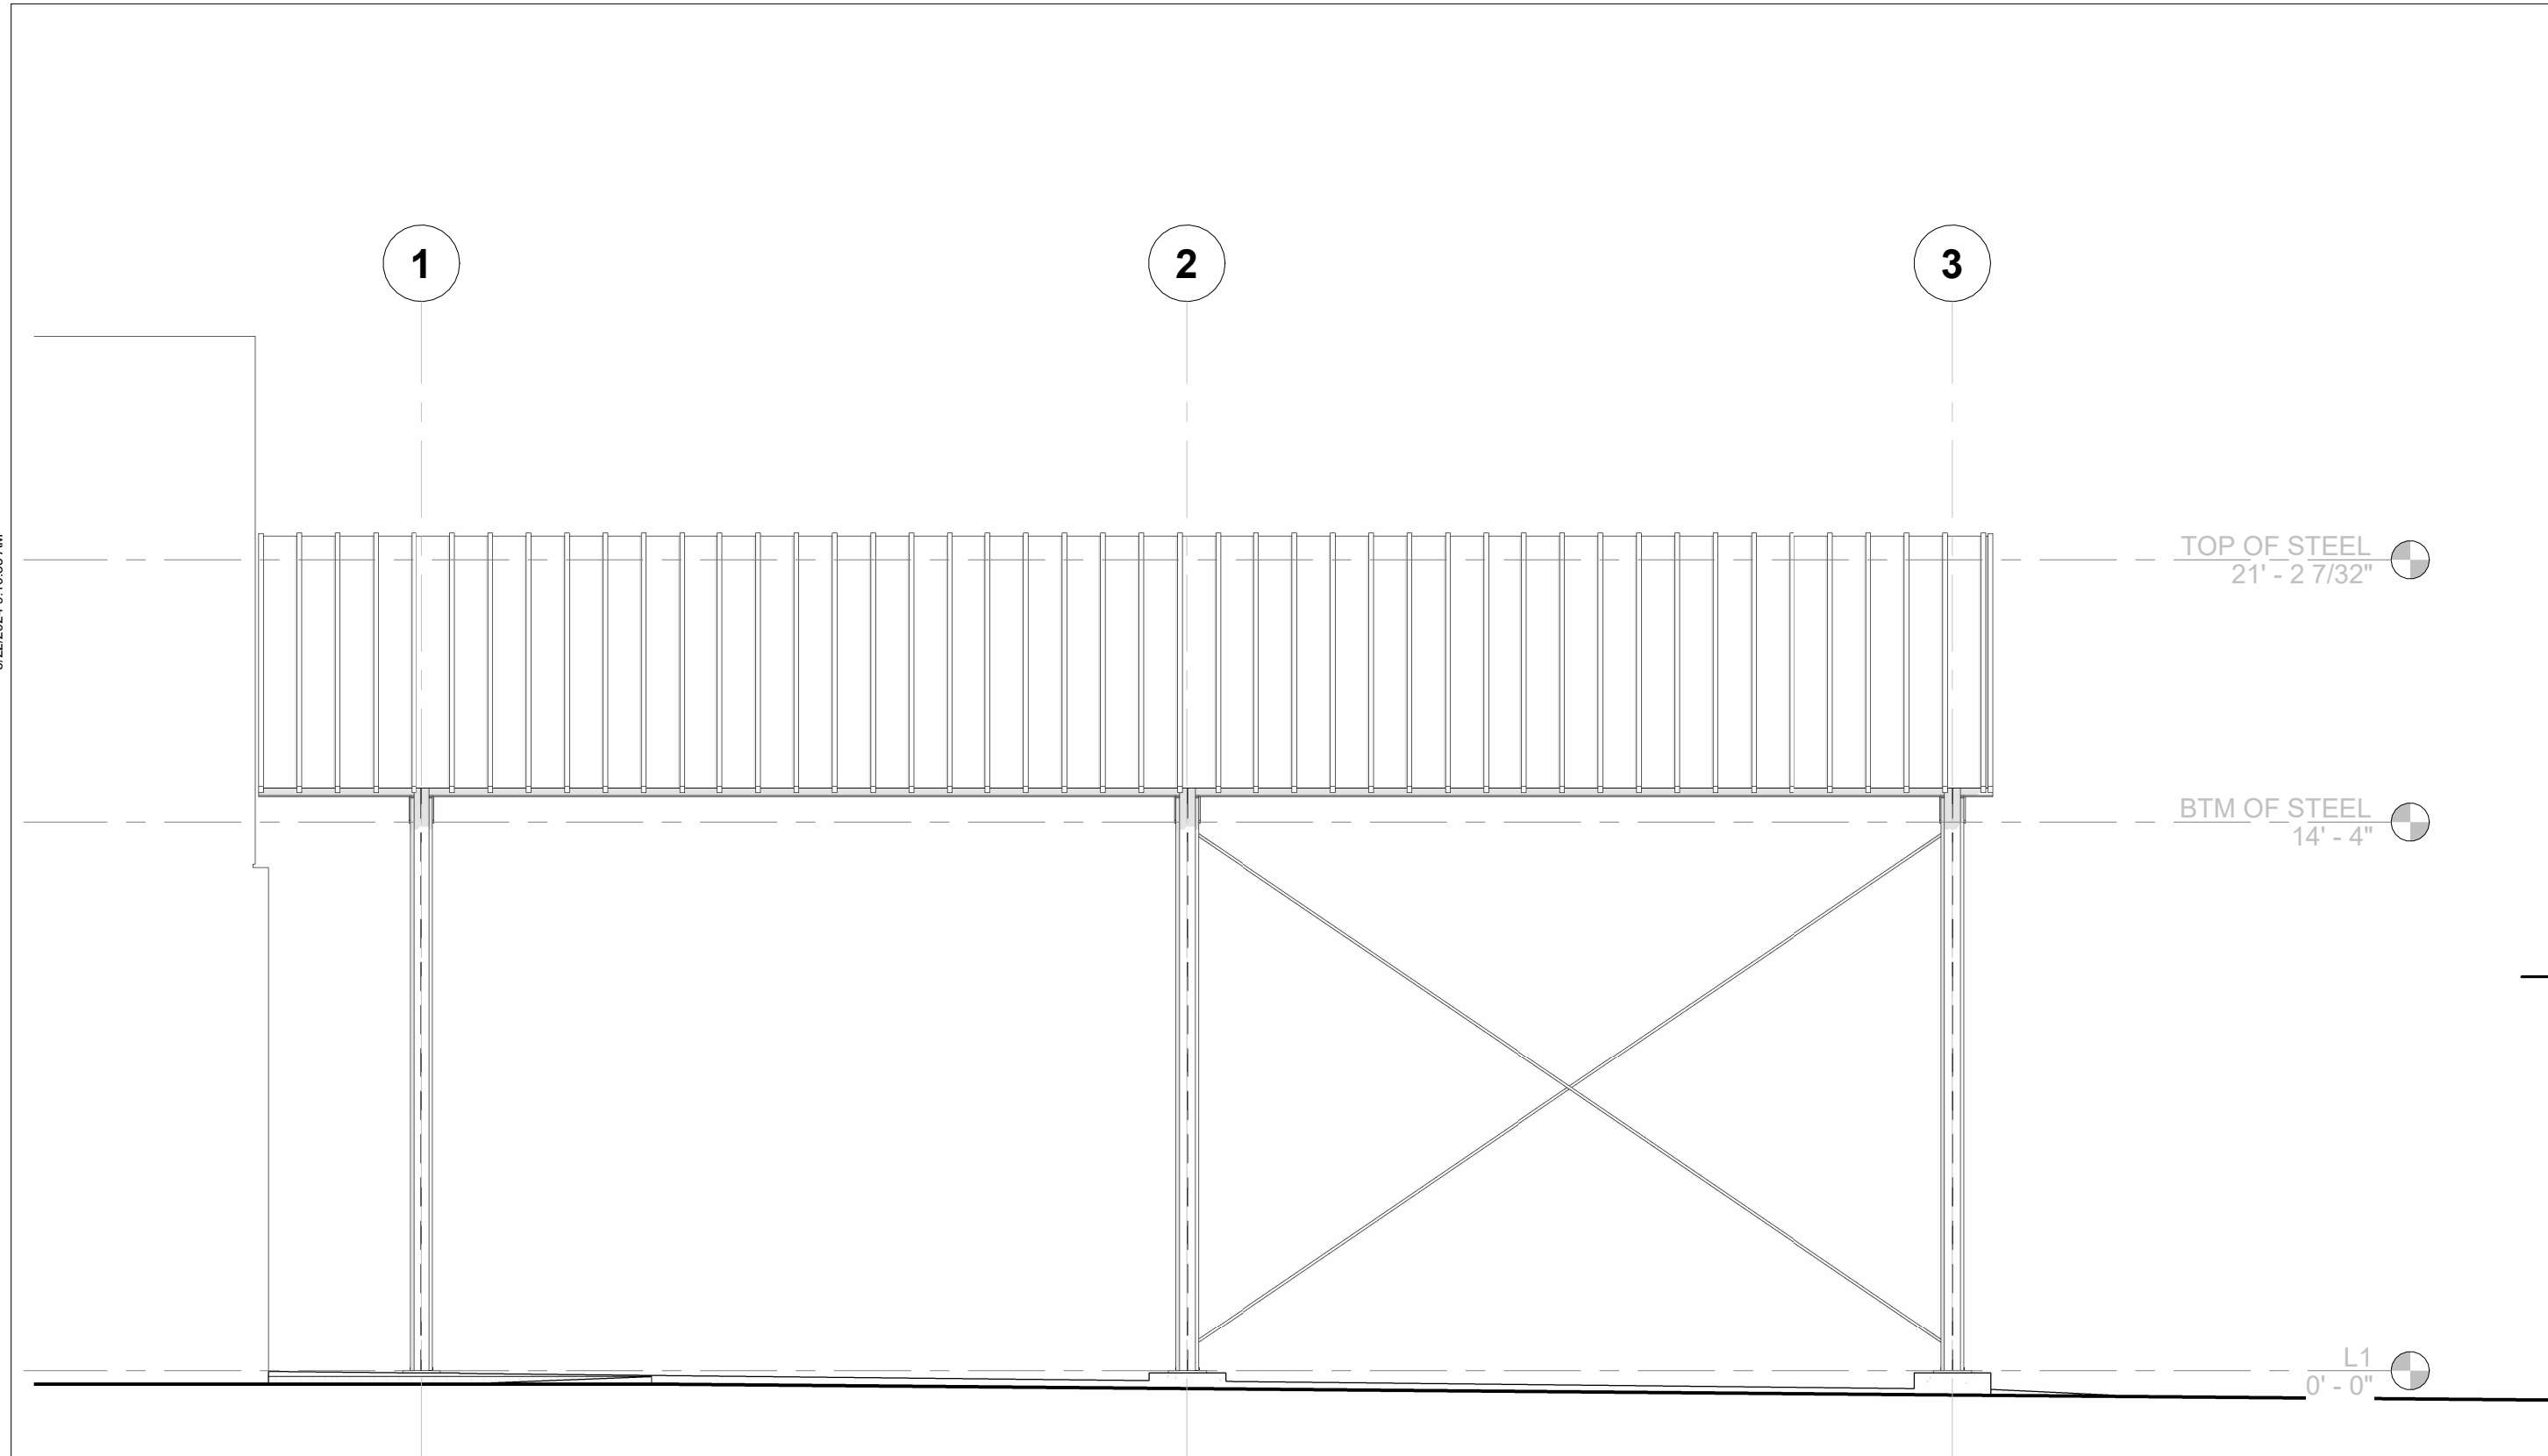
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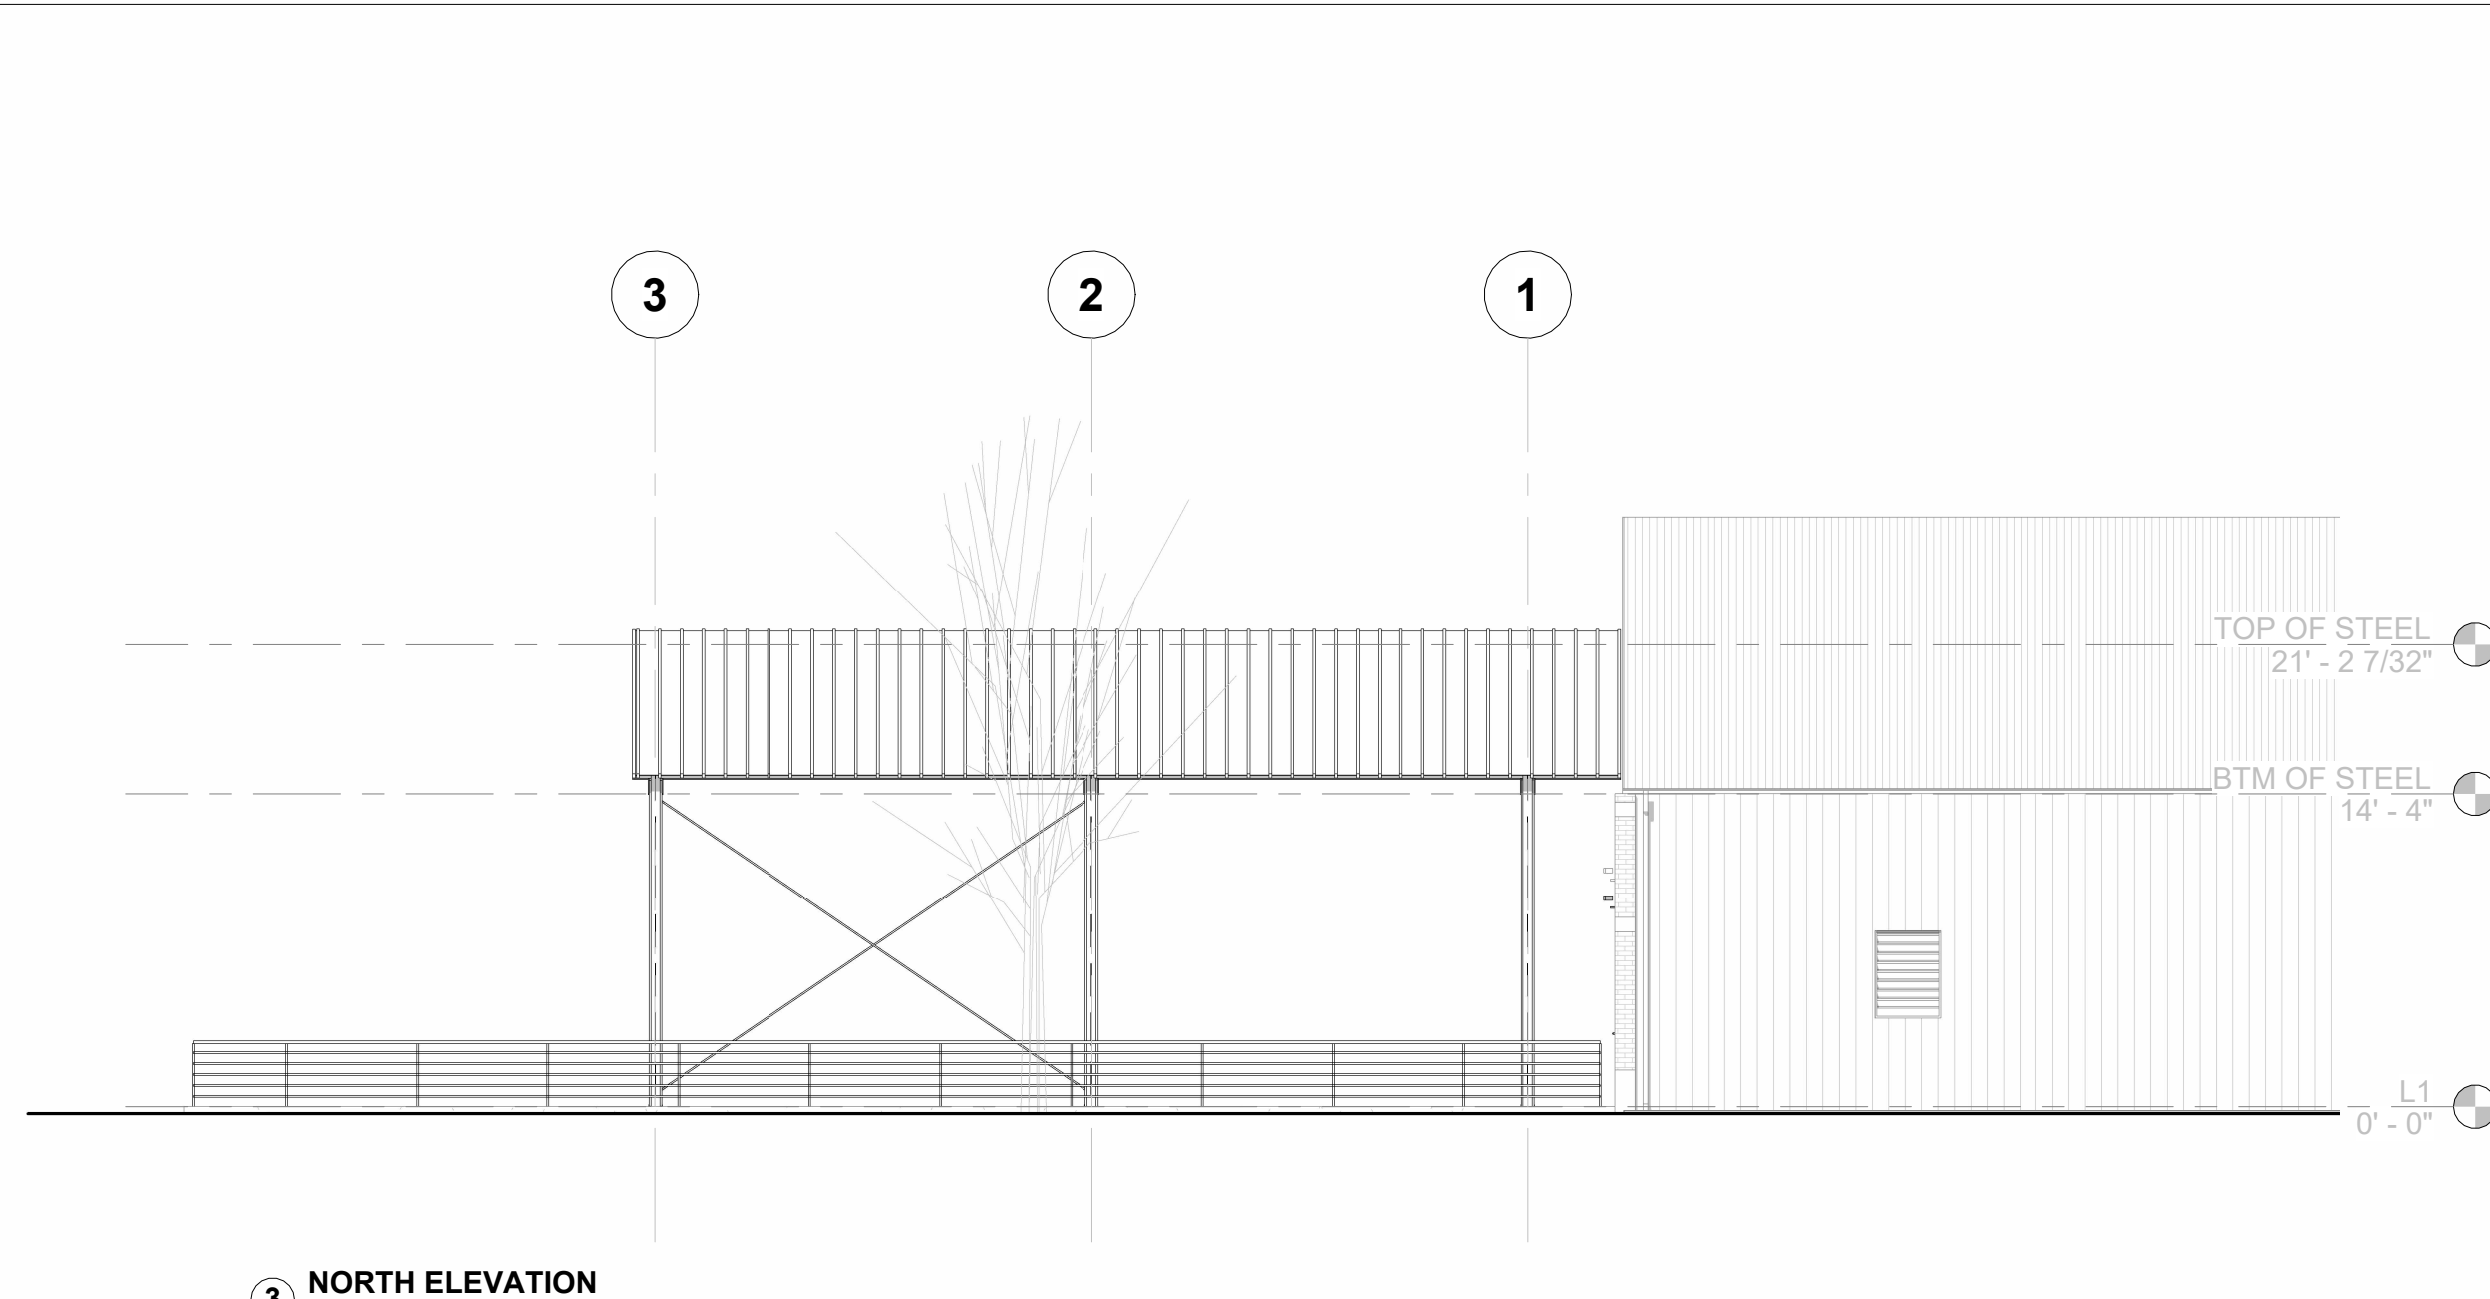
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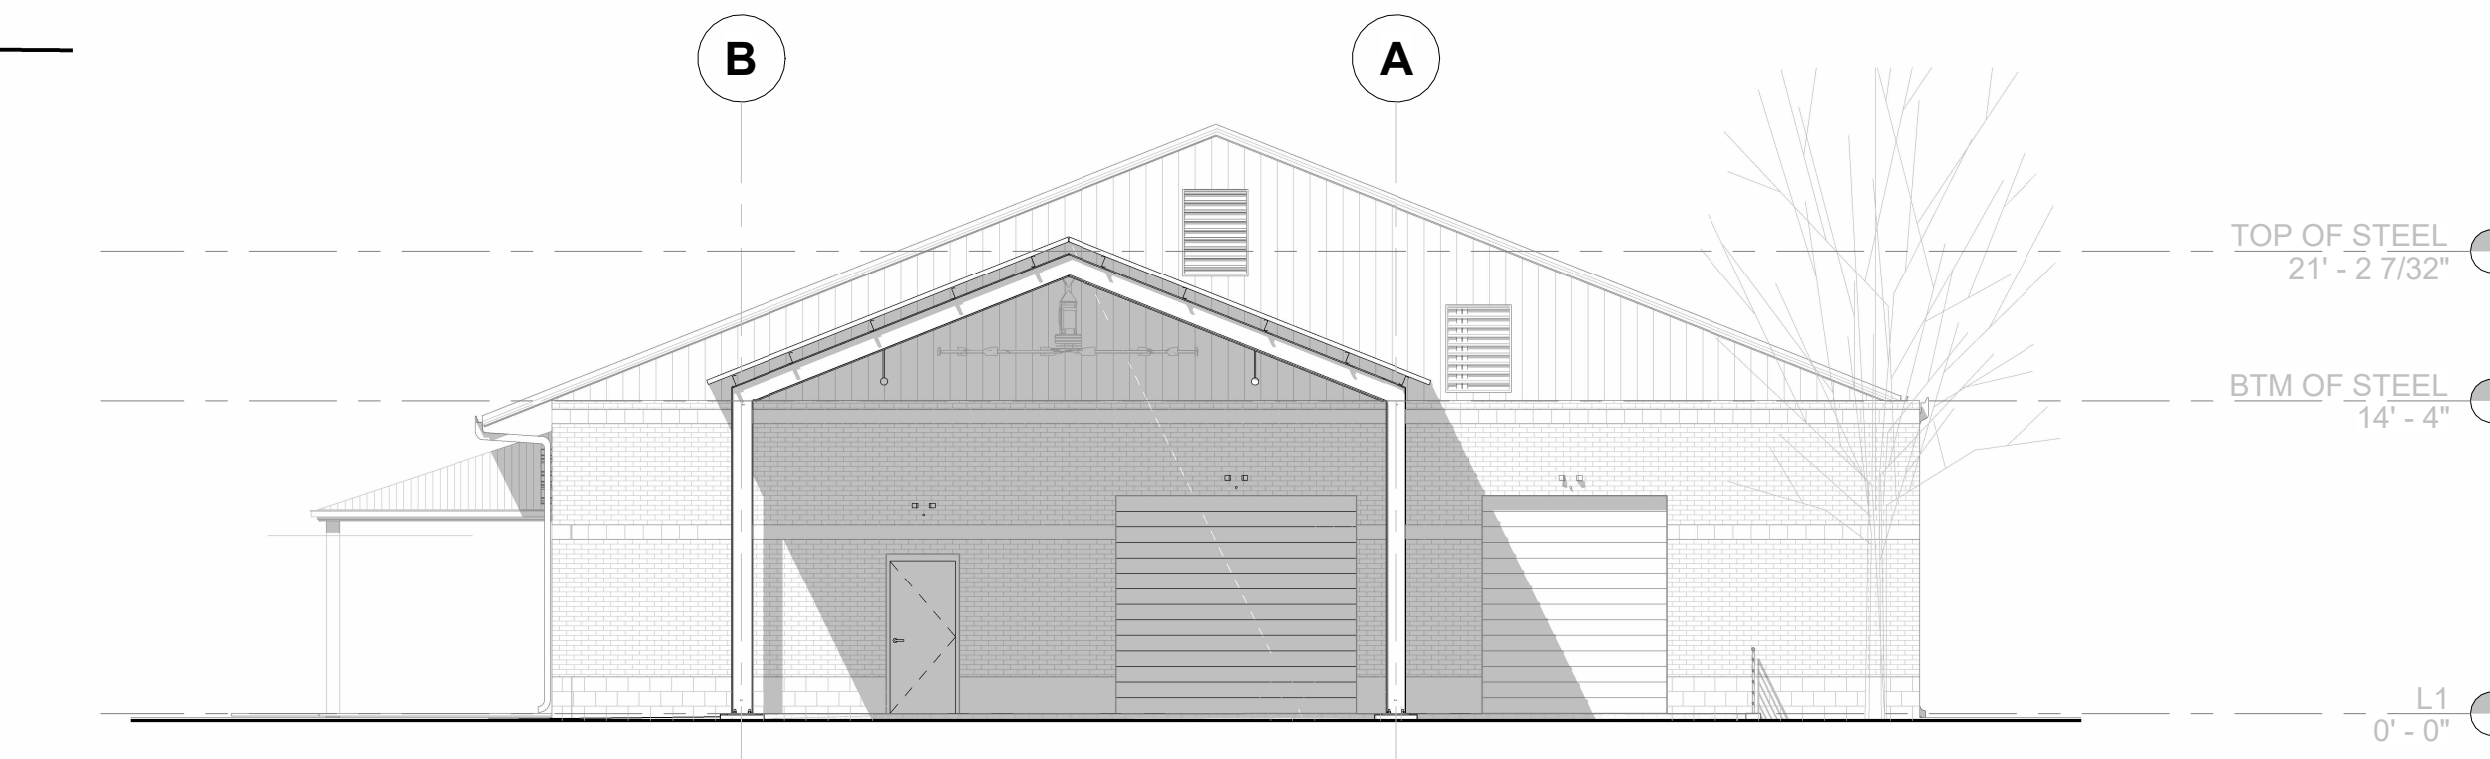
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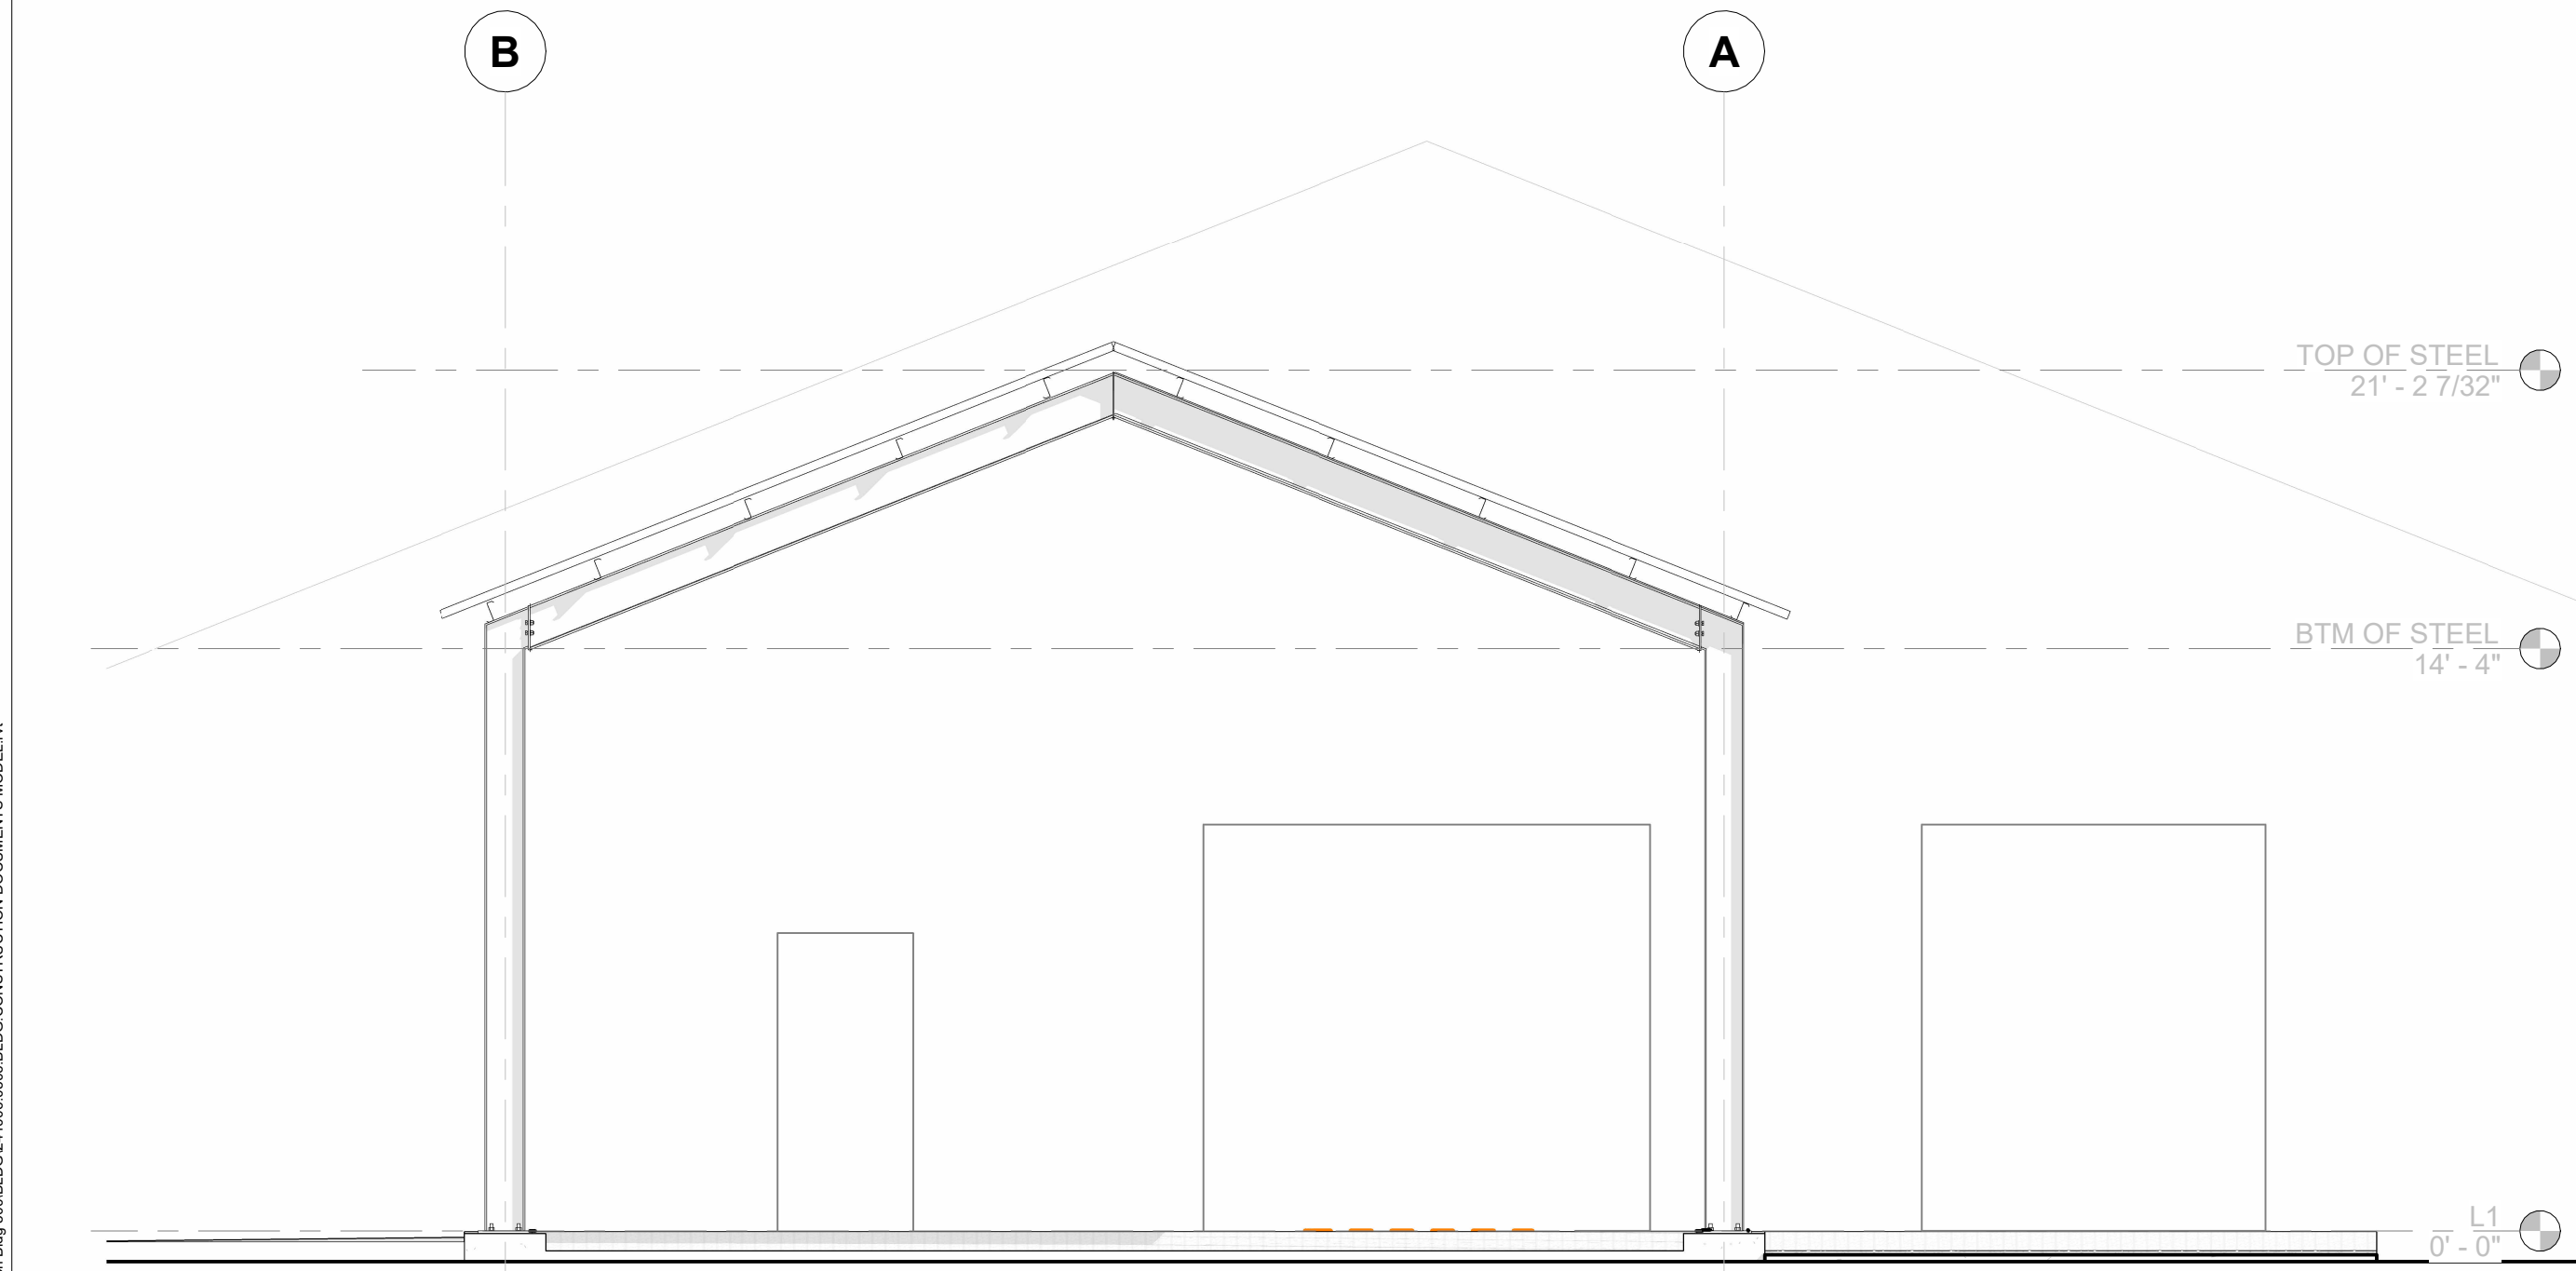
5 SOUTH BUILDING FRAME ELEVATION
SCALE 1/4" = 1'-0"

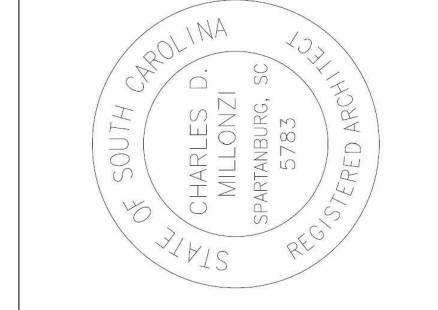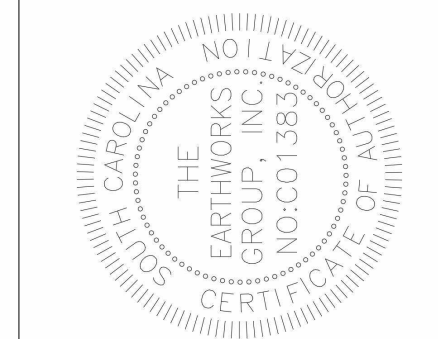


3 NORTH ELEVATION
SCALE 1/8" = 1'-0"



2 EAST ELEVATION
SCALE 1/8" = 1'-0"



4 EAST BUILDING FRAME ELEVATION
SCALE 1/4" = 1'-0"

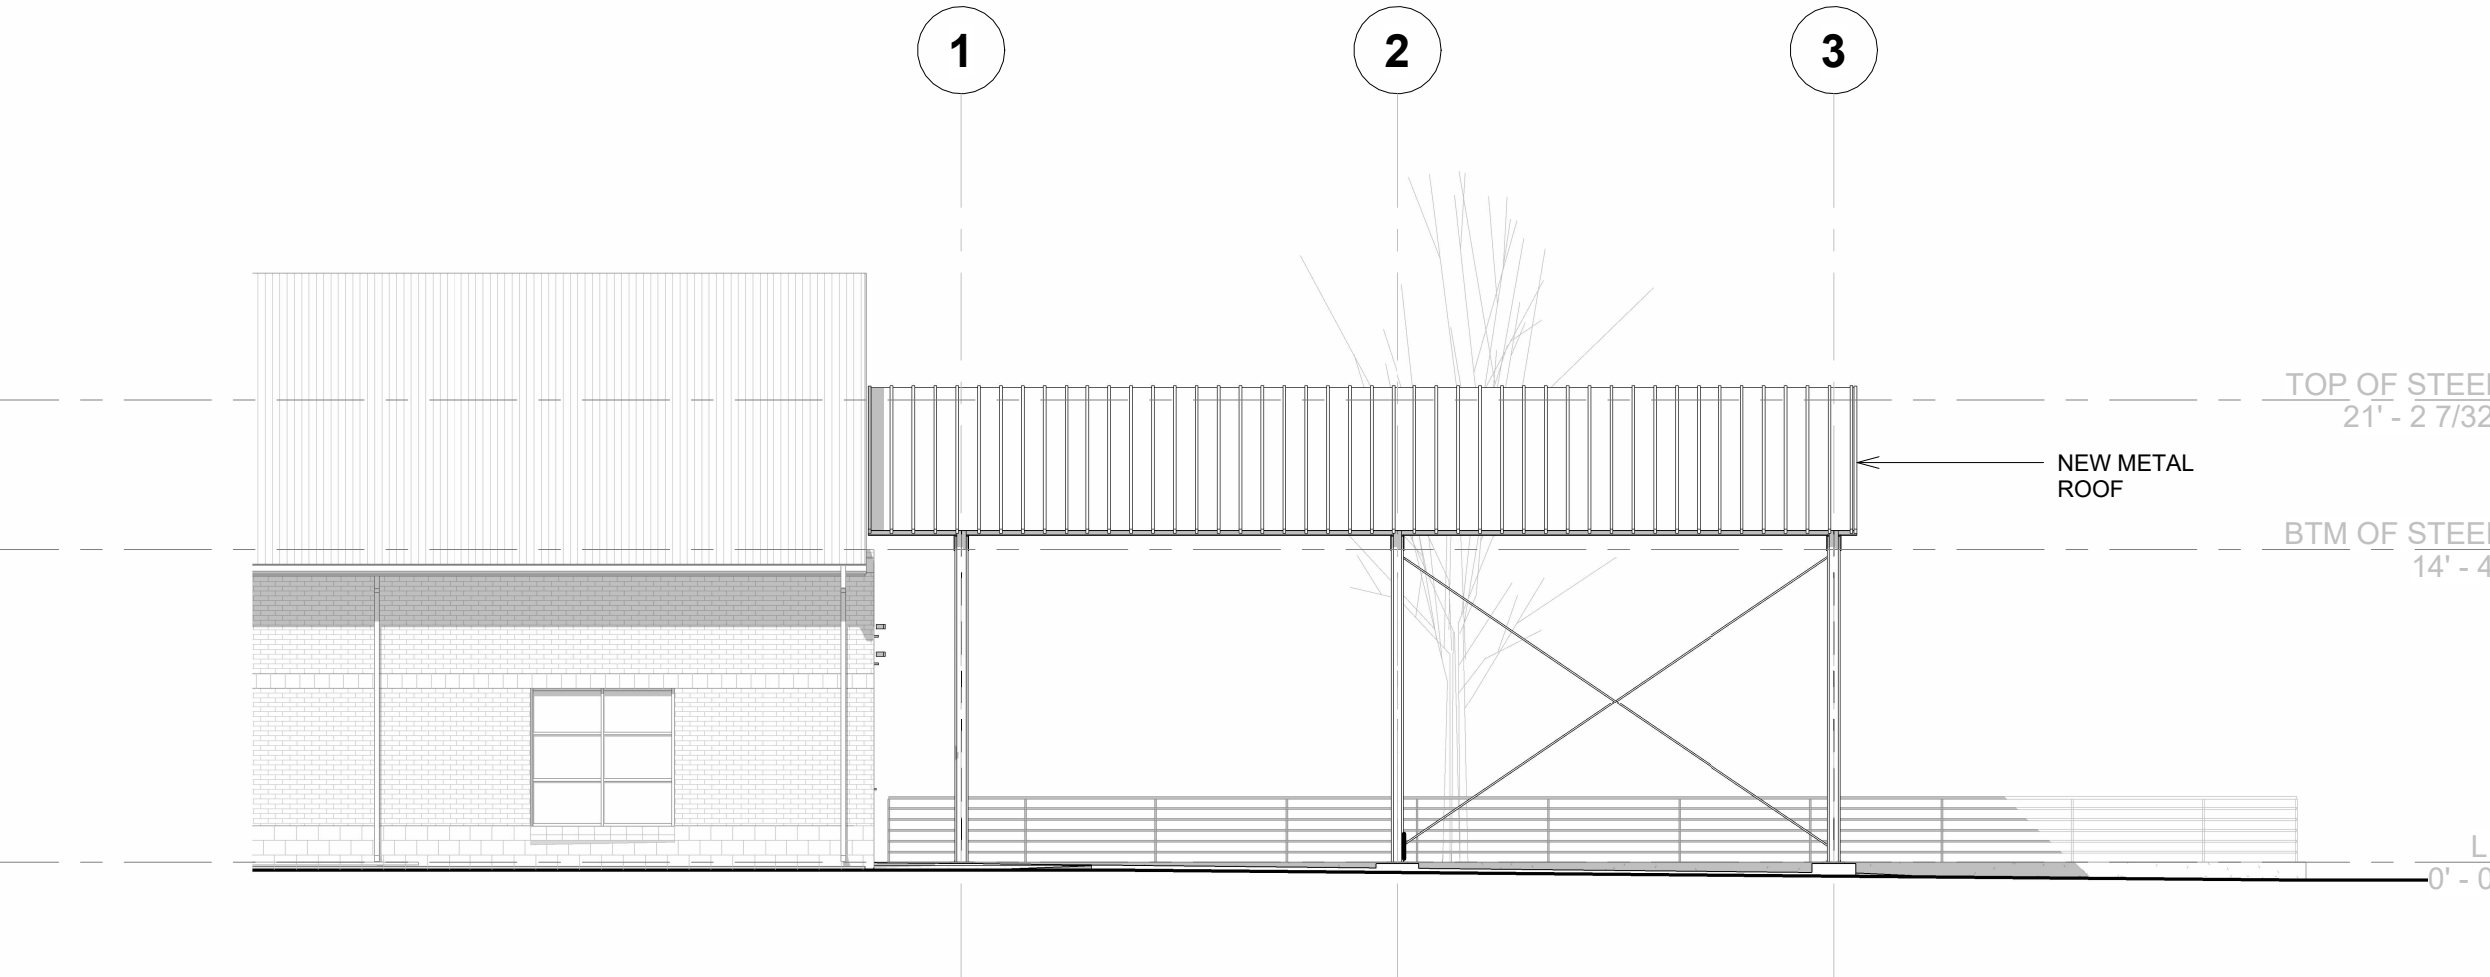

1 SOUTH ELEVATION
SCALE 1/8" = 1'-0"

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STATE OF SOUTH CAROLINA
CHARLES D. MILLENZI
SPARTANBURG, SC
5783
REGISTERED

THE EARTHWORKS GROUP, INC.
1100 COTTONWOOD DRIVE
COLUMBIA, SC 29204
CERTIFICATE OF AUTHORITY

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PROJECT #	241006
DATE	05/13/2024
SCALE	AS NOTED
DESIGNED BY	SS
DRAWN BY	RP
CHECKED BY	SS

BUILDING 500 EXTERIOR CANOPY SHELTER
HENRY-GEORGETOWN TECHNICAL COLLEGE
600 SOUTH MAIN STREET
COLUMBIA, SC 29204

PROPOSED EXTERIOR ELEVATIONS


PREPARED FOR:
HORRY-GEORGETOWN TECHNICAL COLLEGE
B011 BUILDING

A2.02


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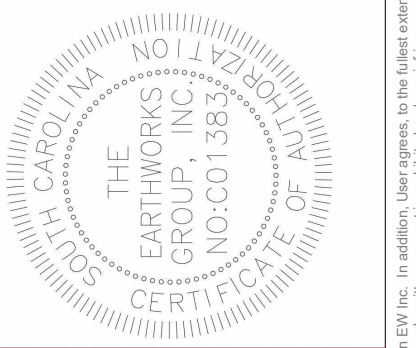
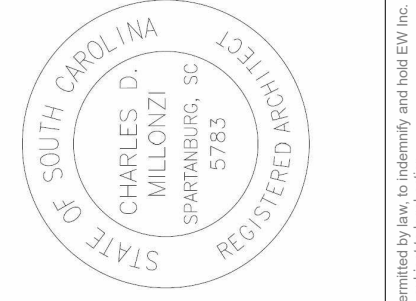


2 PROPOSED LONGITUDINAL SECTION
SCALE 1/4" = 1'-0"

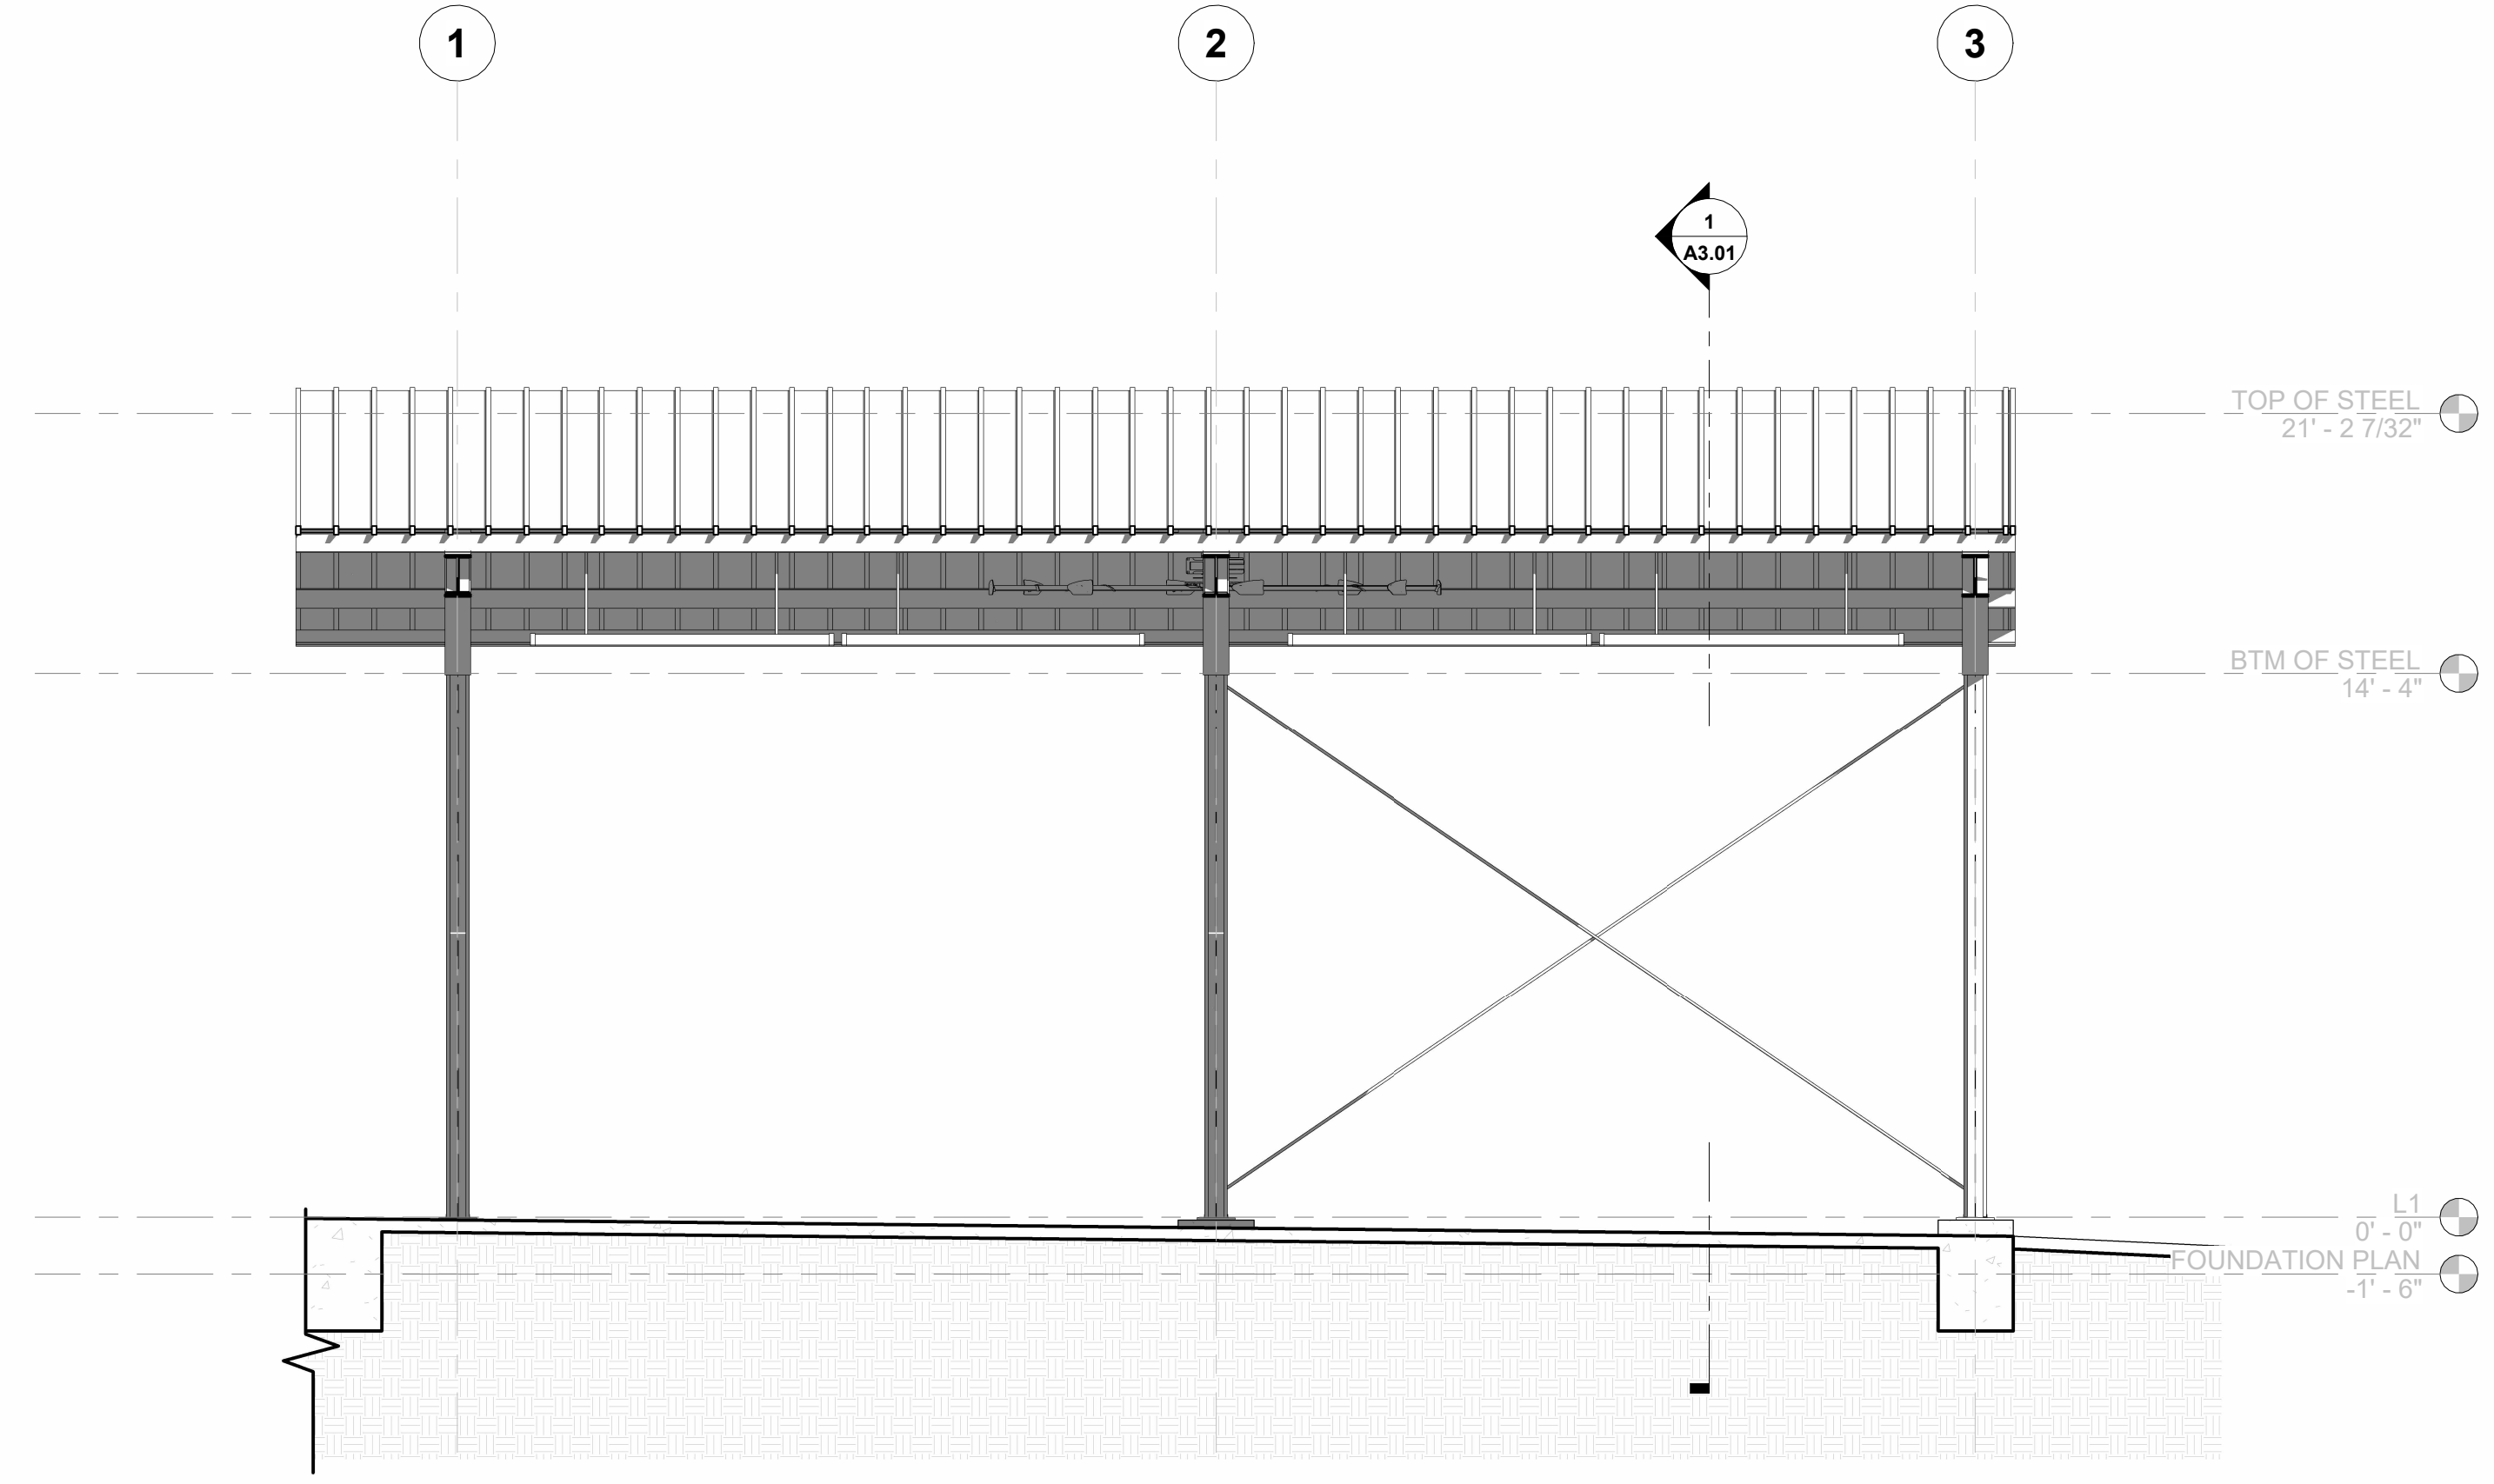

1 PROPOSED BUILDING SECTION
SCALE 1/4" = 1'-0"

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12	***	***

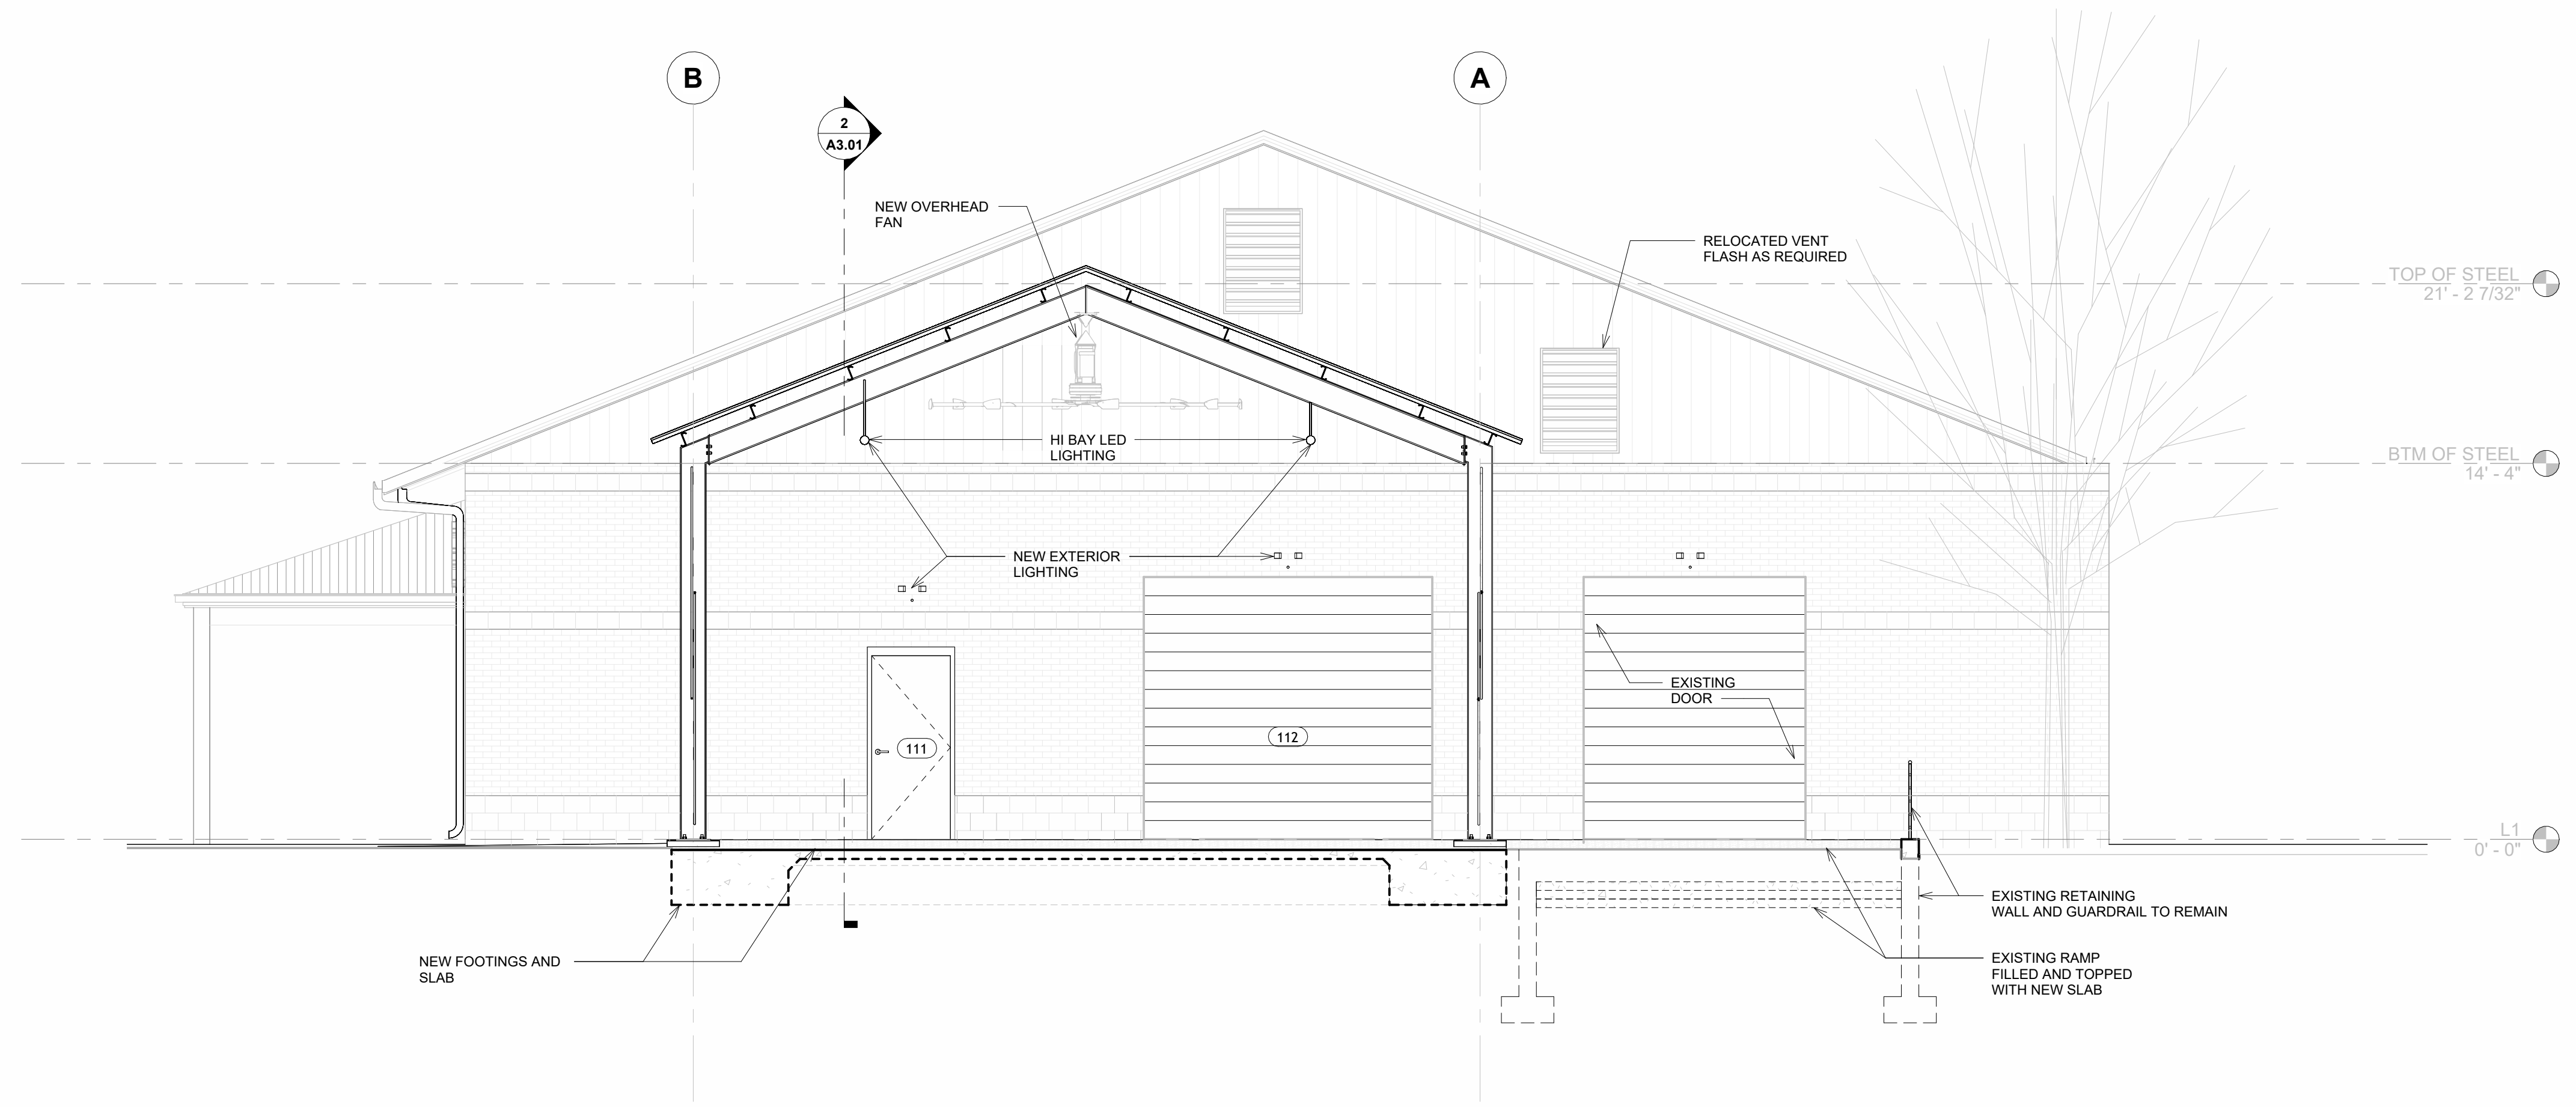PROJECT #	241006
DATE	05/13/2024
SCALE	AS NOTED
DESIGNED BY	SS
DRAWN BY	RP
CHECKED BY	SS

BUILDING 500 EXTERIOR CANOPY SHELTER
HENRY GEORGETOWN TECHNICAL COLLEGE
608 SOUTH MAIN STREET
GEORGETOWN, SC 29526

BUILDING SECTIONS


PREPARED FOR:
HORRY-GEORGETOWN TECHNICAL COLLEGE
BOTH BUILDING

A3.01


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2 EXISTING RAMP SECTION
SCALE 1/4" = 1'-0"




3 LOADING DOCK INFILL AND RAMP JOINT DETAIL
SCALE 3/4" = 1'-0"

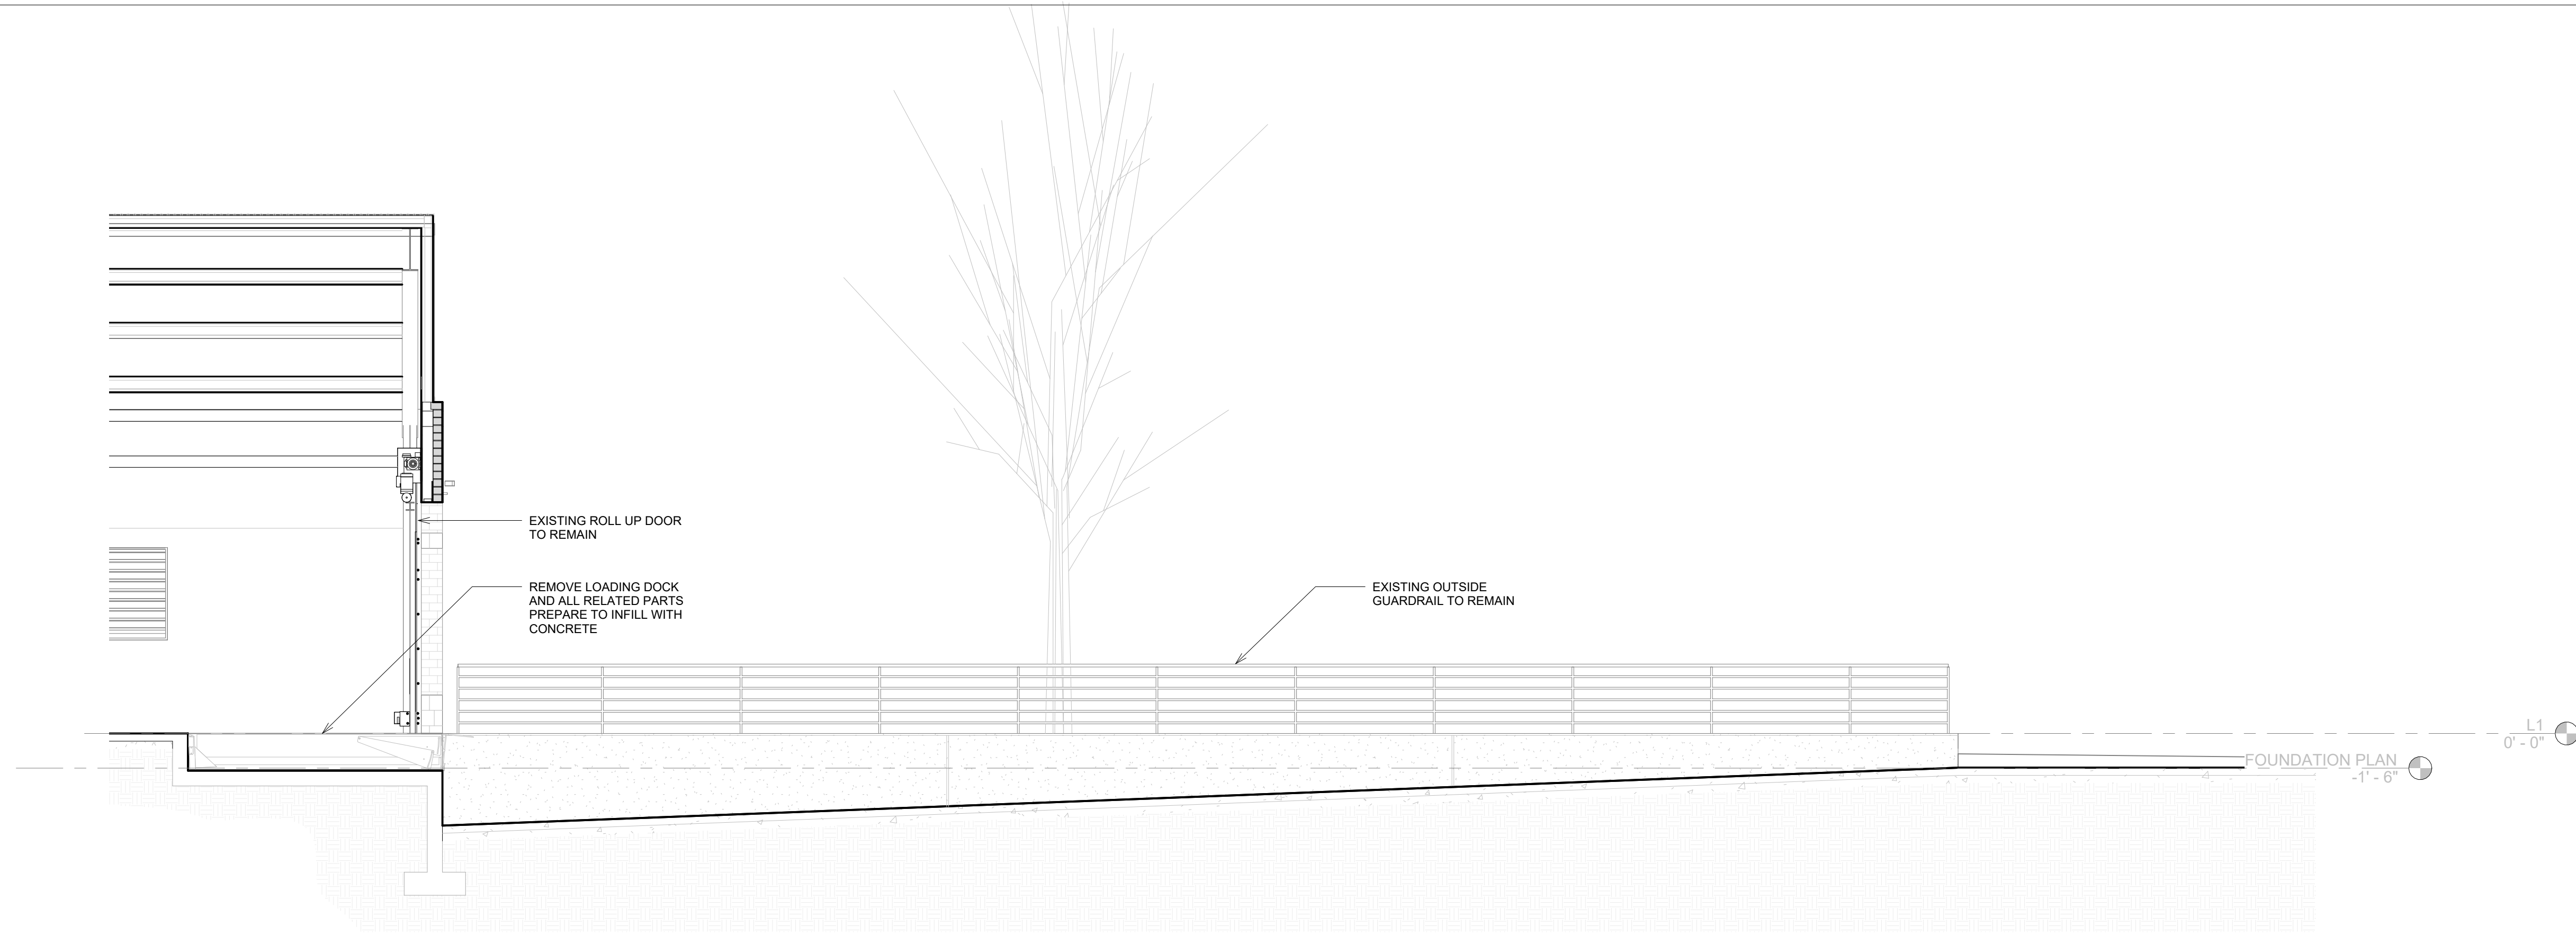1 PROPOSED RAMP SECTION
SCALE 1/4" = 1'-0"

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3	BY: [Redacted] DATE: [Redacted]
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11	BY: [Redacted] DATE: [Redacted]
12	BY: [Redacted] DATE: [Redacted]

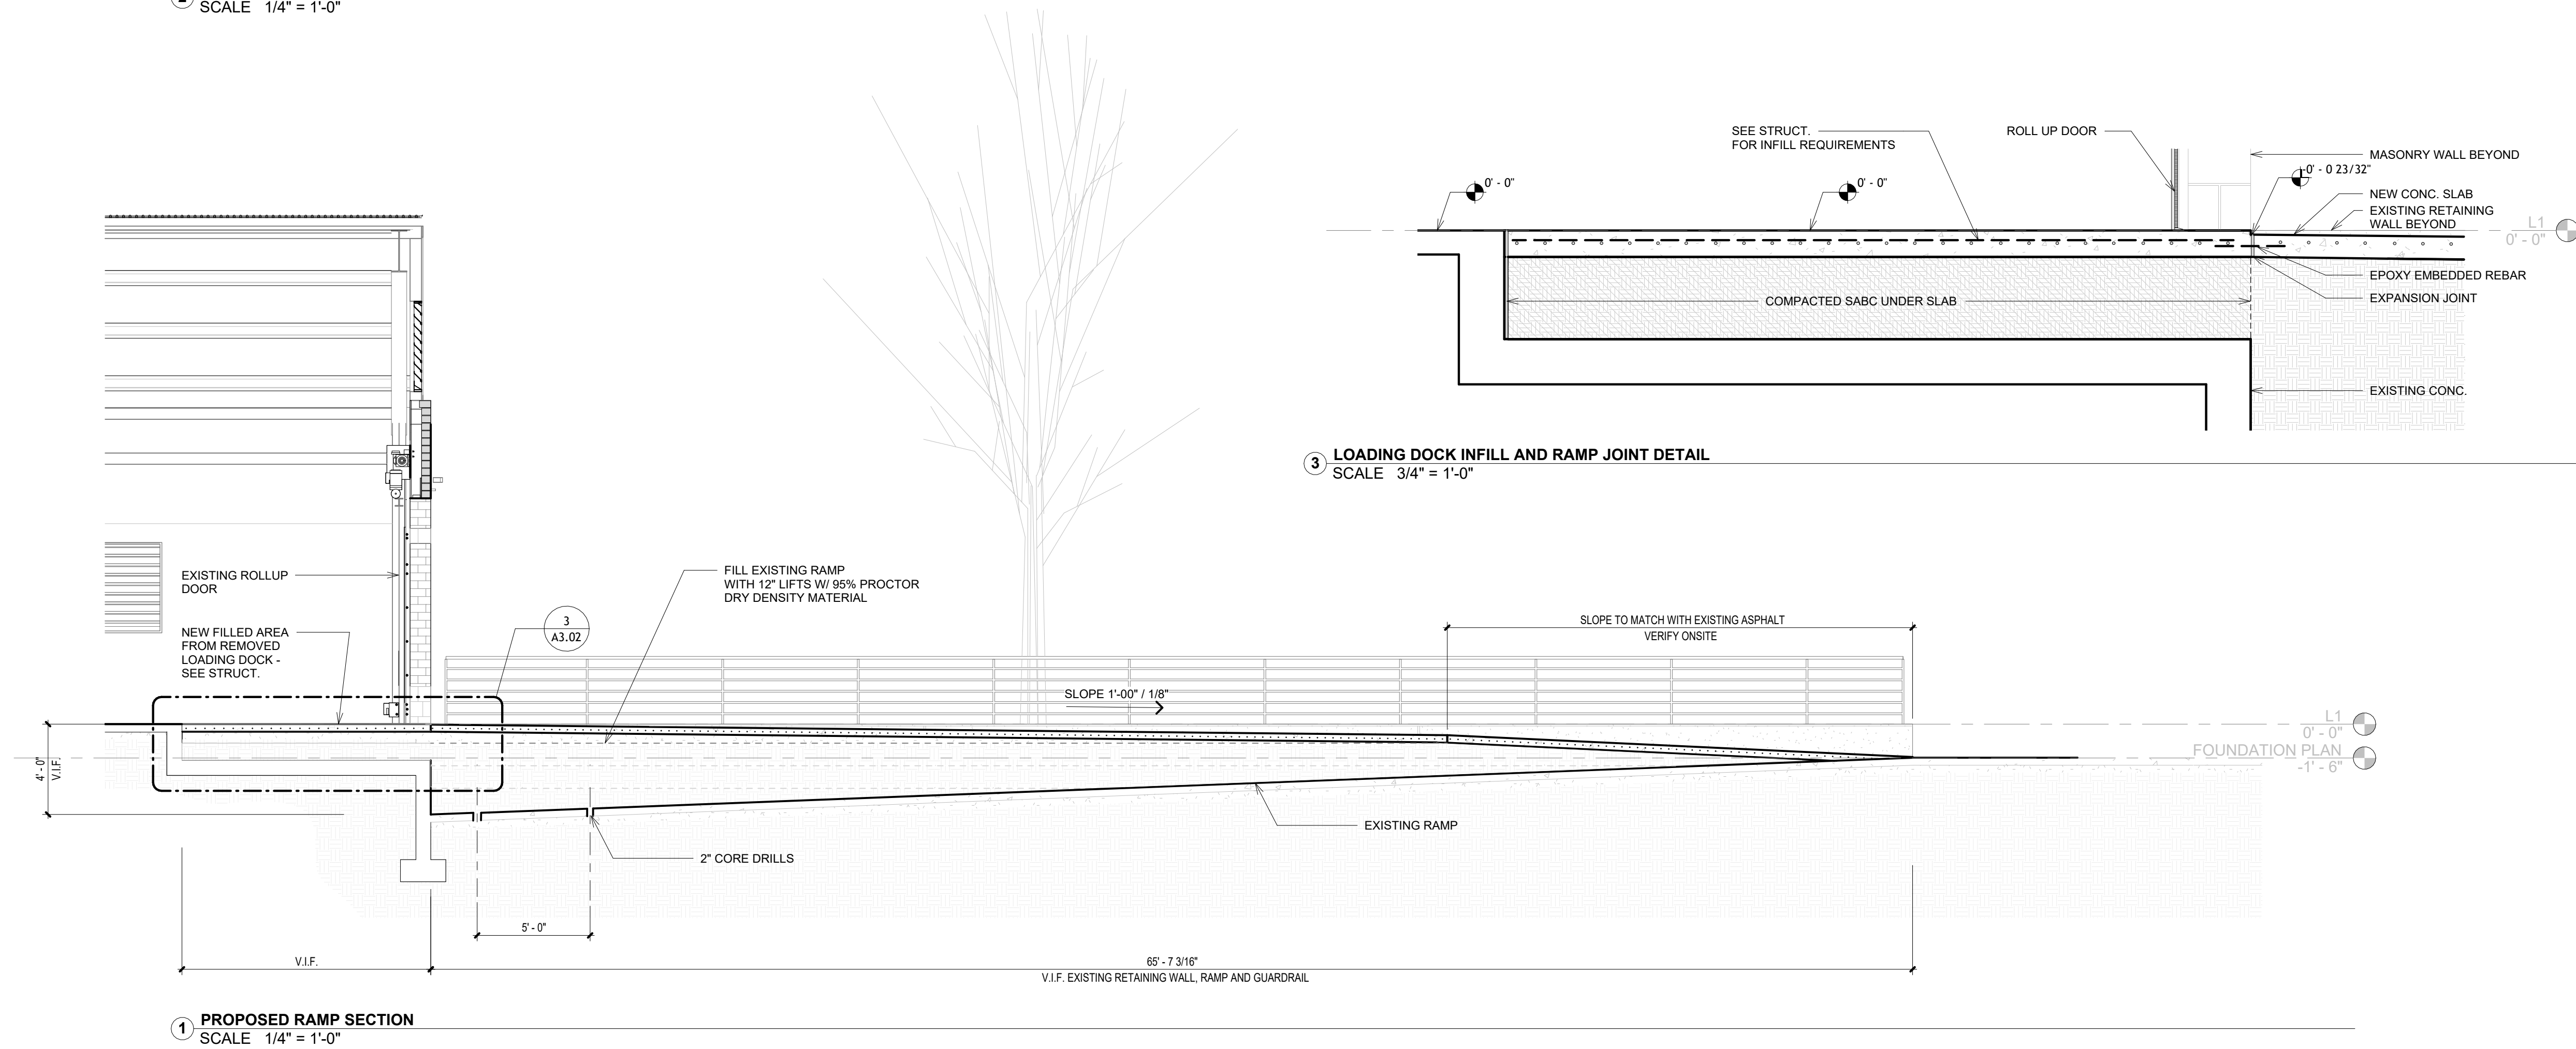BUILDING 500 EXTERIOR CANOPY SHELTER
HENRY GEORGETOWN TECHNICAL COLLEGE
6008 SOUTH TRAVIS STREET
GEORGETOWN, SC 29526

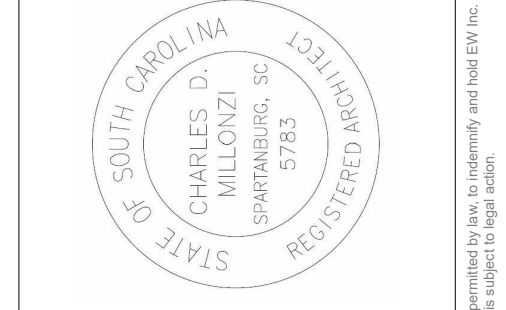BUILDING SECTIONS

PREPARED FOR:
HORRY-GEORGETOWN TECHNICAL COLLEGE
B011 BUILDING


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DATE: 05/13/2024
SCALE: AS NOTED
DESIGNED BY: Designer
DRAWN BY: Author
CHECKED BY: Checker

A3.02


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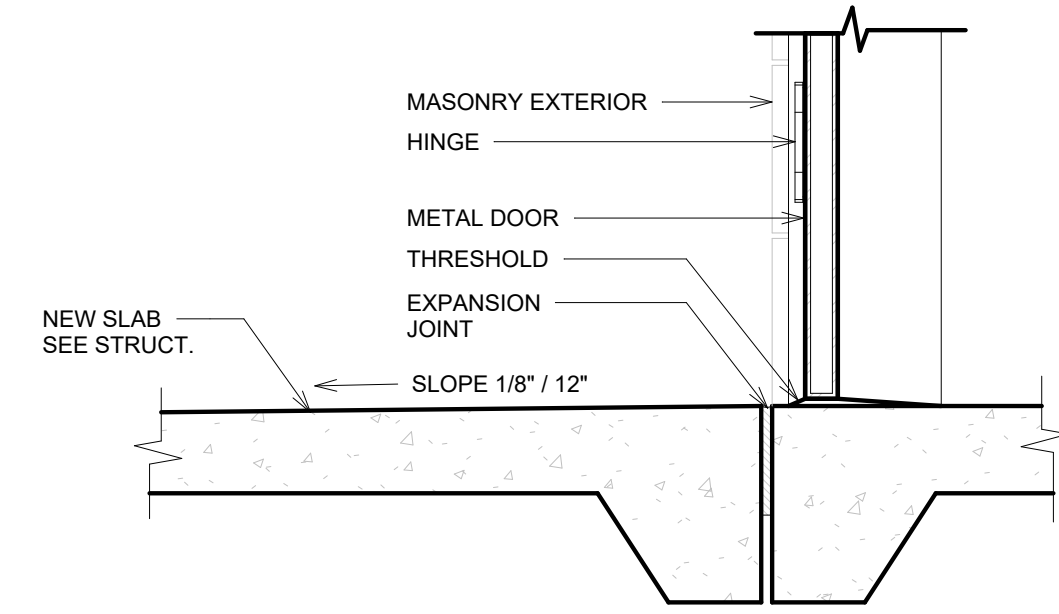
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5 ROLL UP JAMB DETAIL
SCALE 1 1/2" = 1'-0"




4 ROLL UP DOOR HEAD DETAIL
SCALE 1/2" = 1'-0"

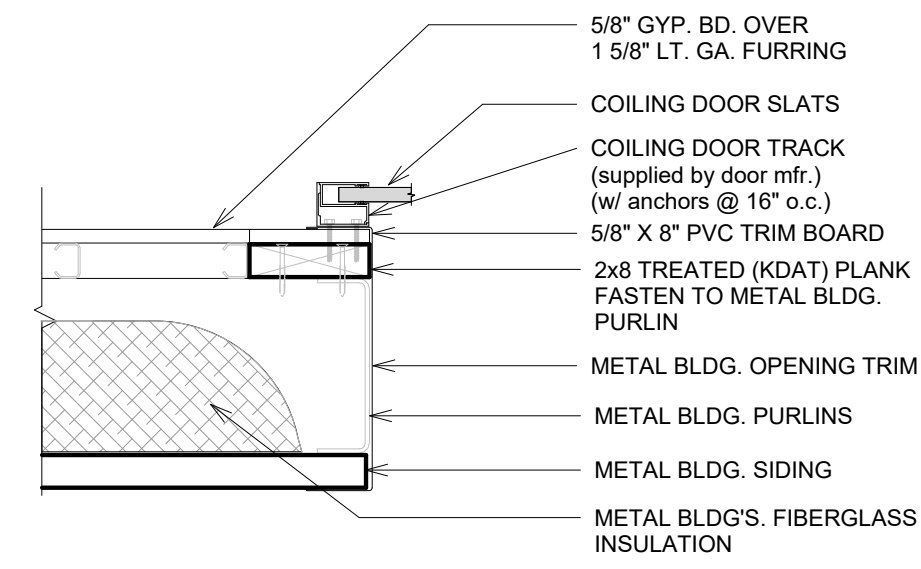


3 MAN DOOR SILL DETAIL
SCALE 1 1/2" = 1'-0"

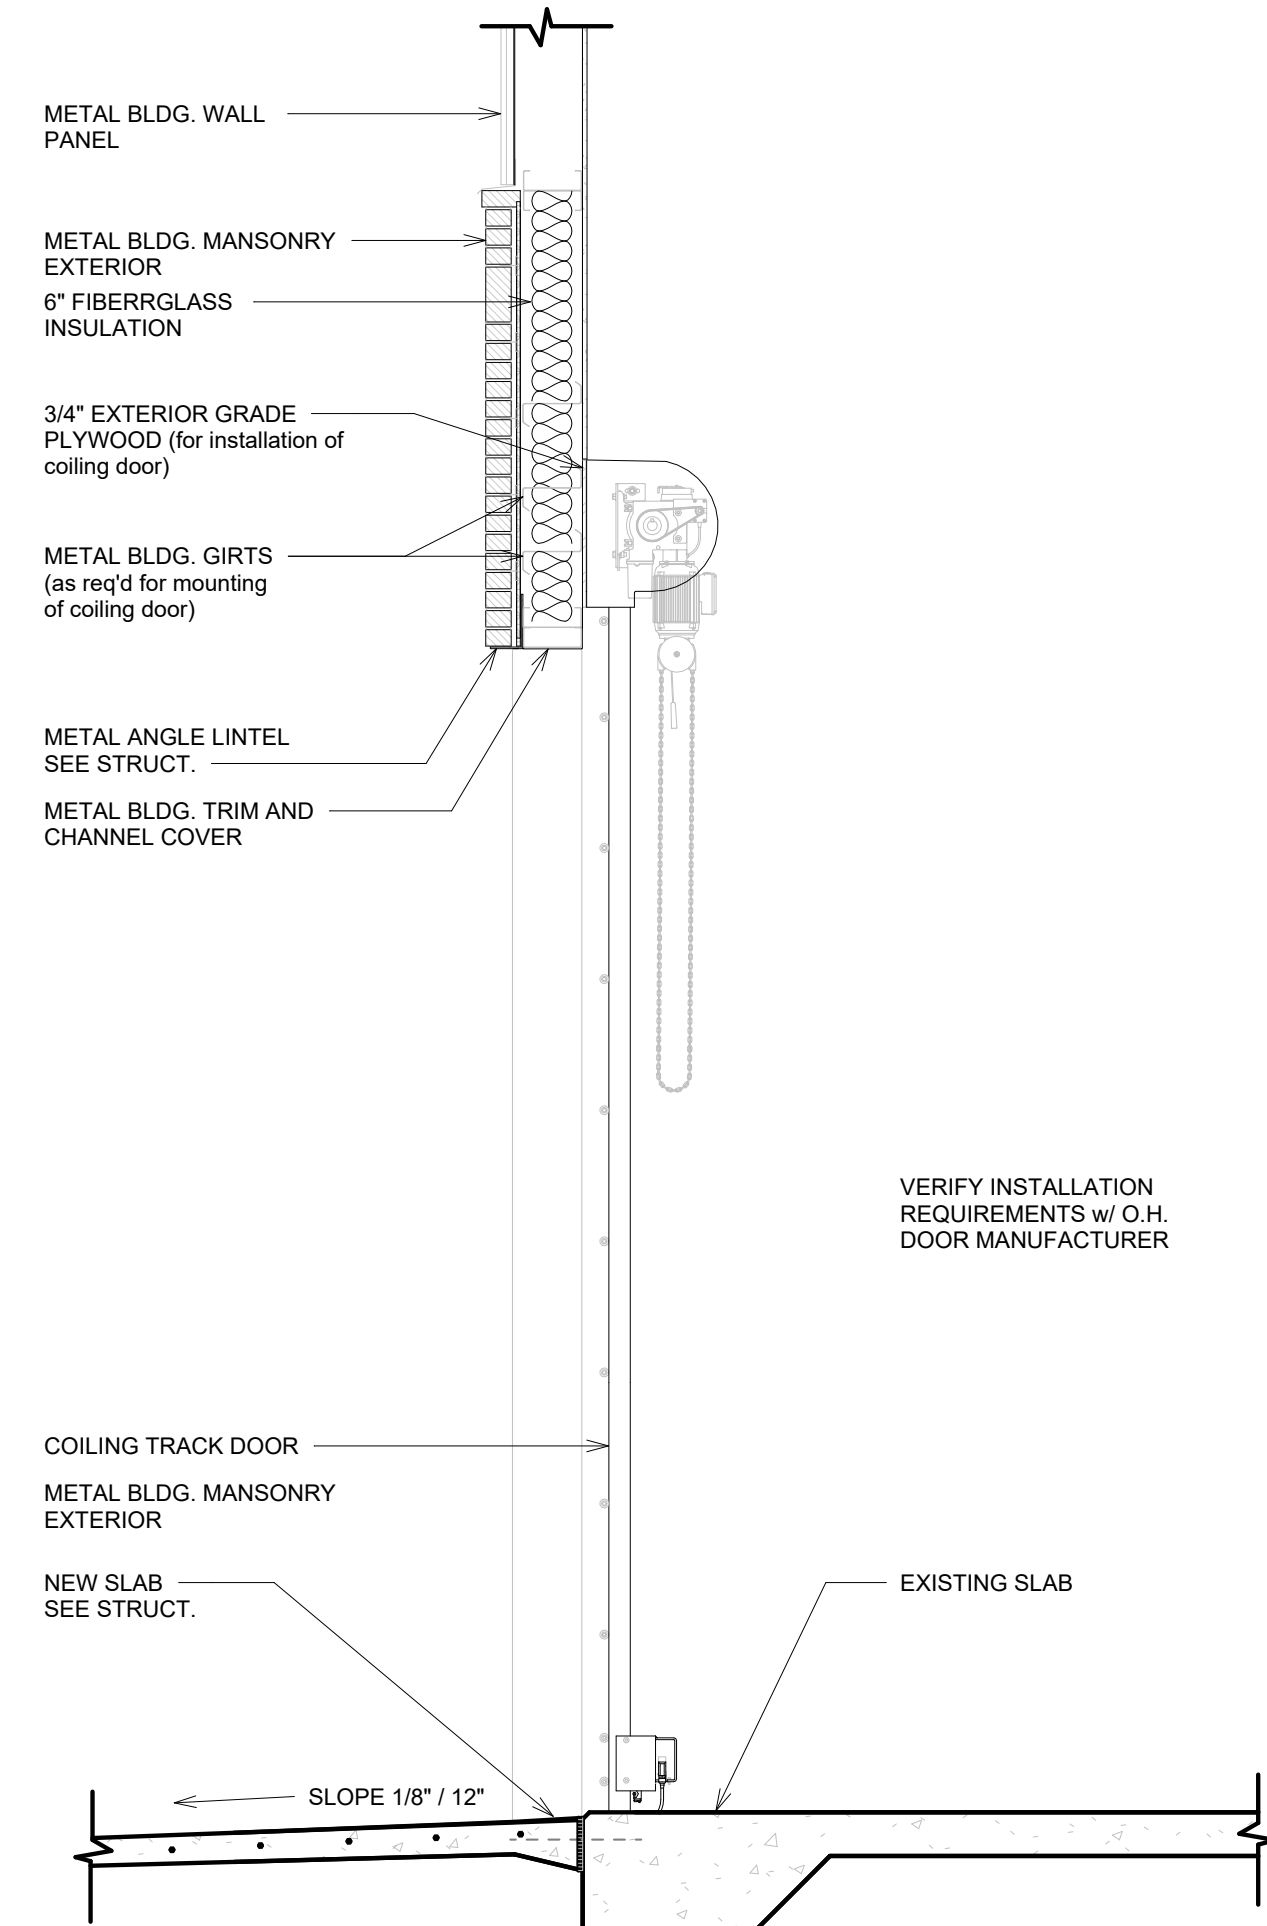
Mark	Door				Frame							Hardware		Comments		
	Width	Size		Thickness	Material	Finish	Material	Type	Finish	Head	Jamb	Sill	Fire Rating Label		Set No.	From Room: Number
		Height	Height													
111	3'-0"	7'-0"	7'-0"	0" - 1 3/4"	METAL	PAINTED	METAL	EXISTING DOOR	PAINTED	1/A6.01	2/A6.01	3/A6.01	YES			RELOCATED EXISTING DOOR
112	11'-0"	10'-0"	10'-0"	0" - 3"	METAL	PAINTED	METAL	MODEL 620	PAINTED	4/A6.01	5/A6.01	SEE MANUF.	YES	101		CONTACT PAUL SHOOP pshoop@ohdgs.com

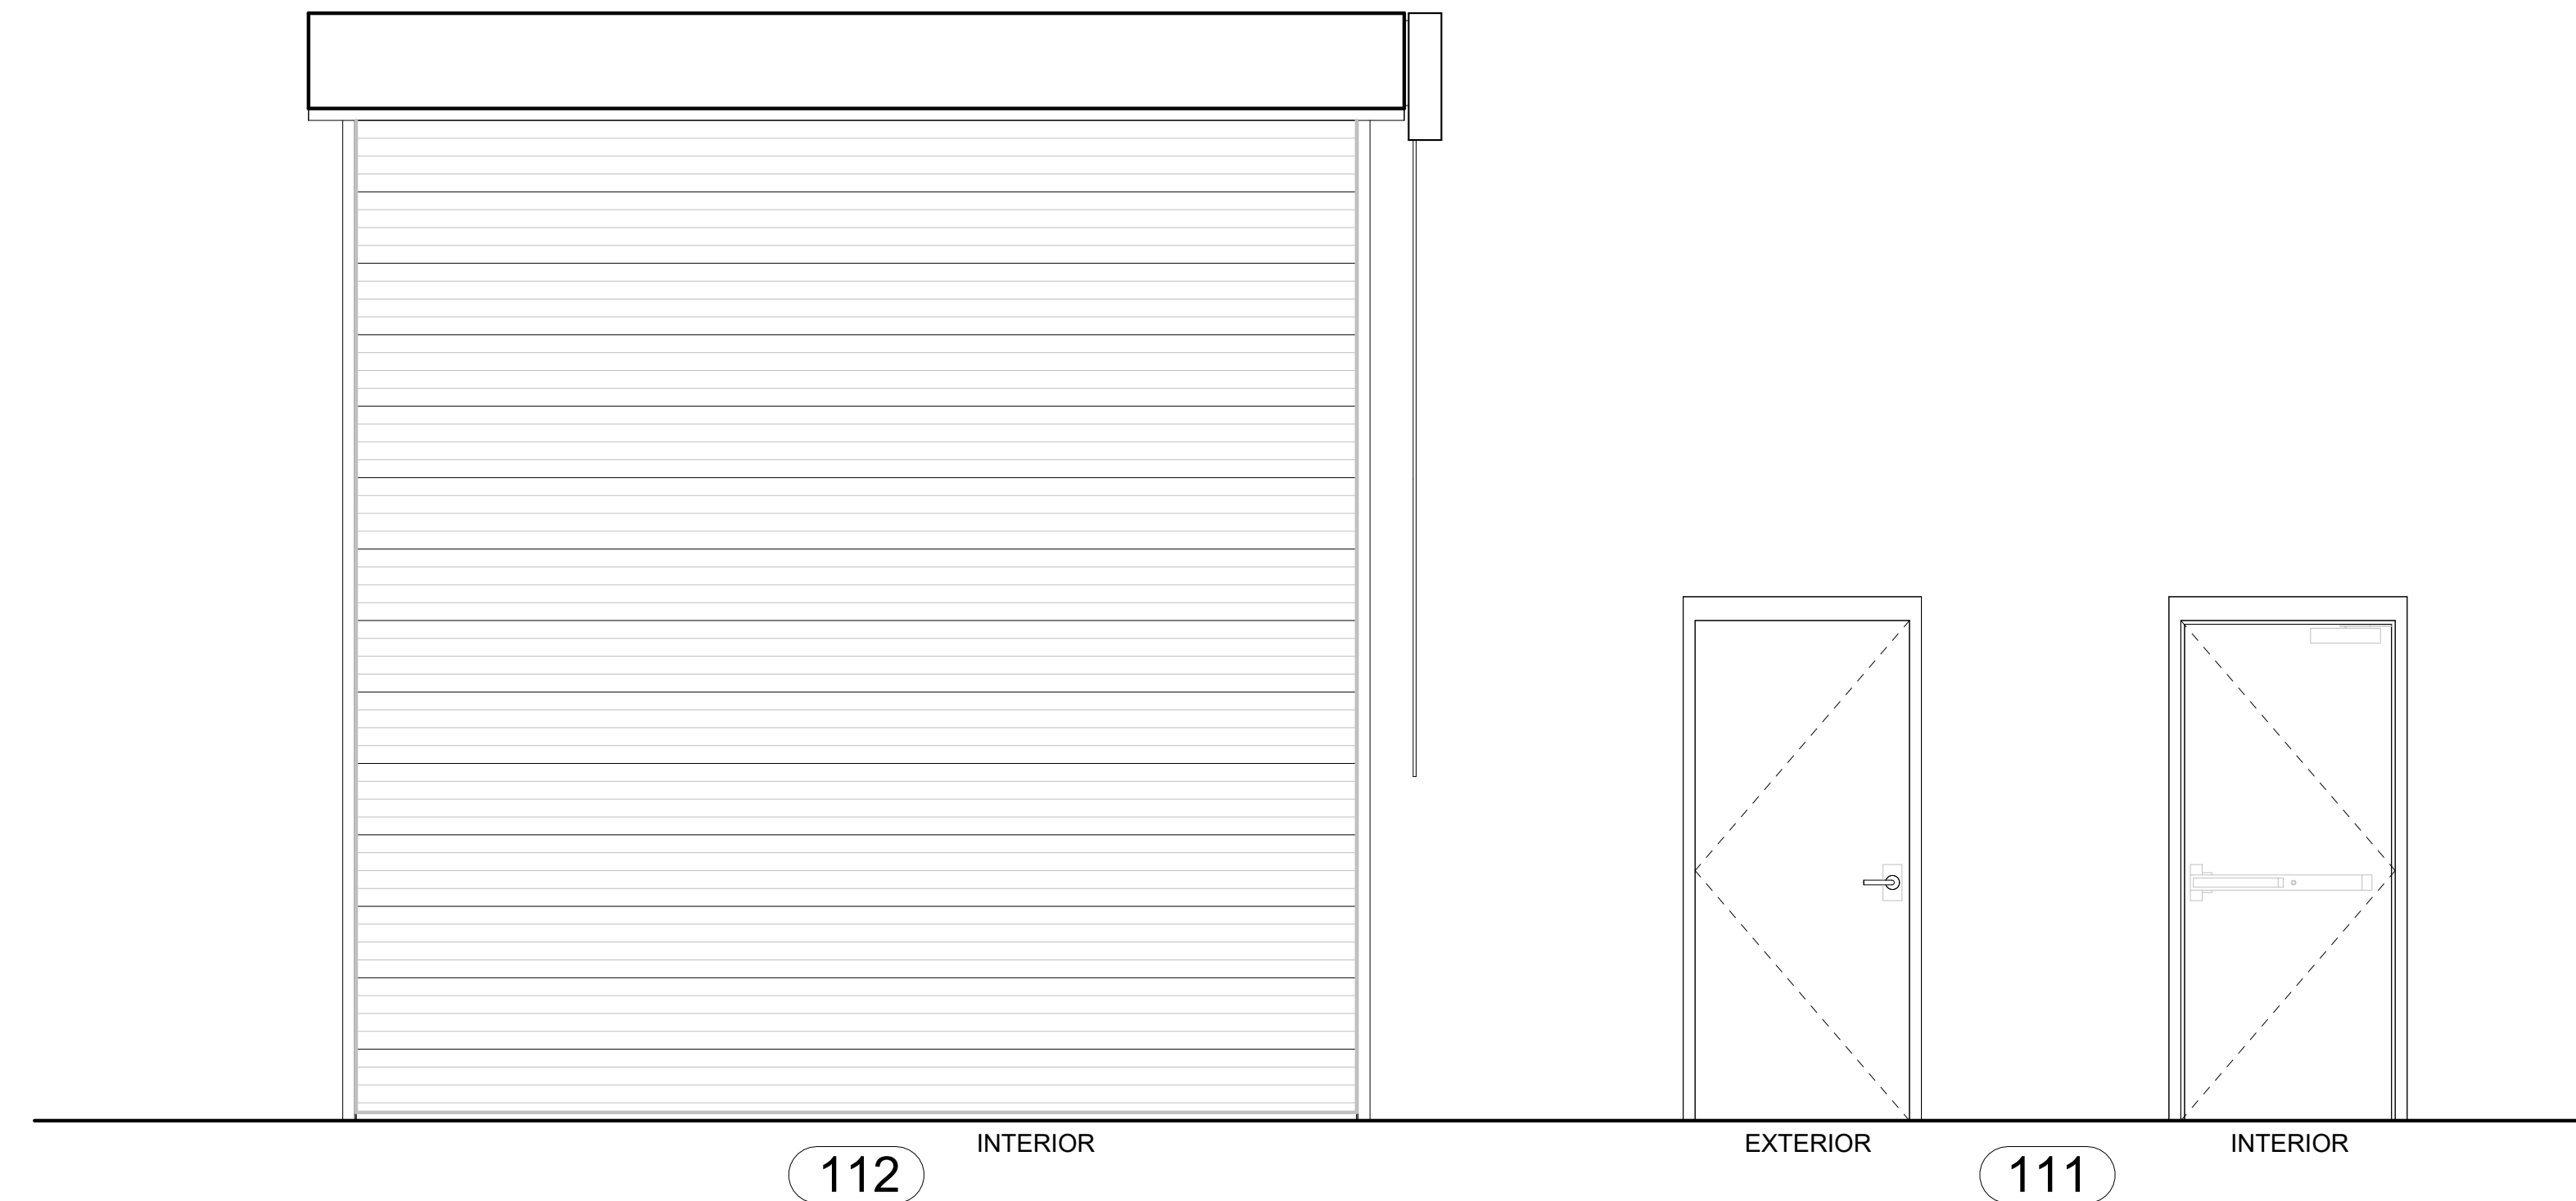

DOORS
SCALE 1/2" = 1'-0"

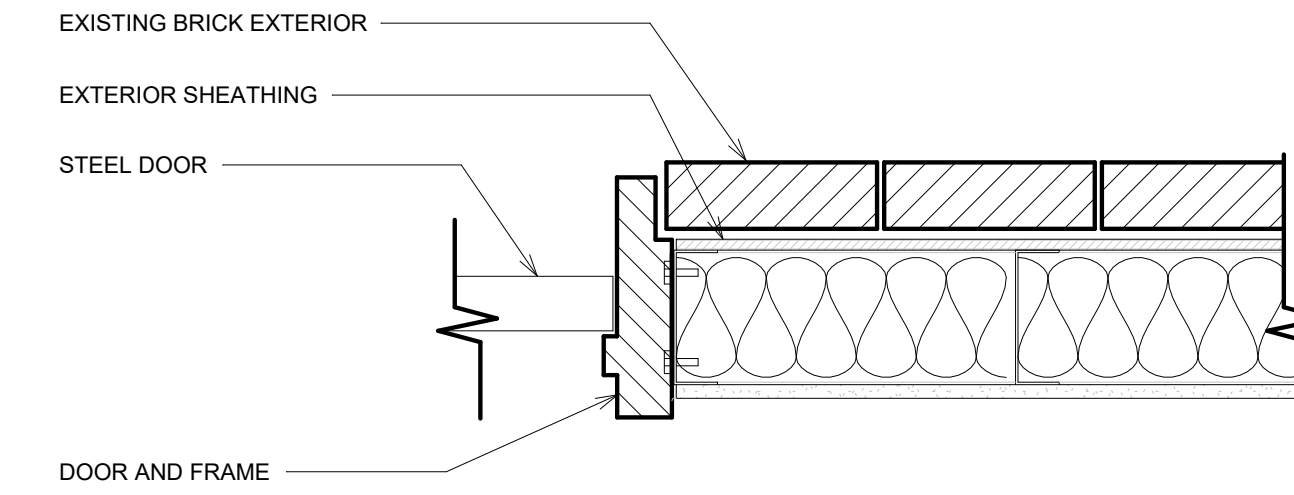

2 MAN DOOR JAMB DETAIL
SCALE 1 1/2" = 1'-0"

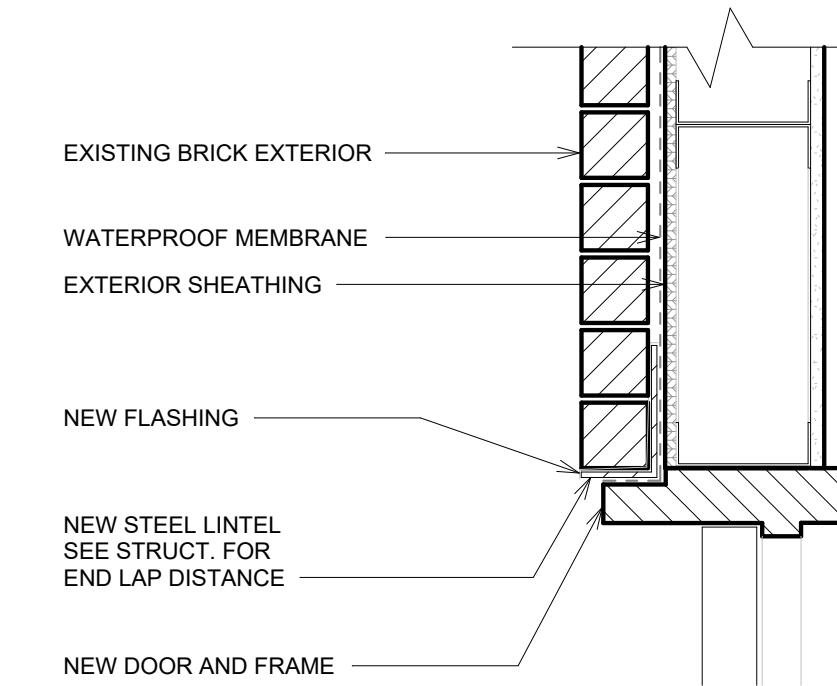

1 MAN DOOR HEAD DETAIL
SCALE 1 1/2" = 1'-0"

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SPRINGFIELD, SC 29783
REGISTERED

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COLUMBIA, SC 29204
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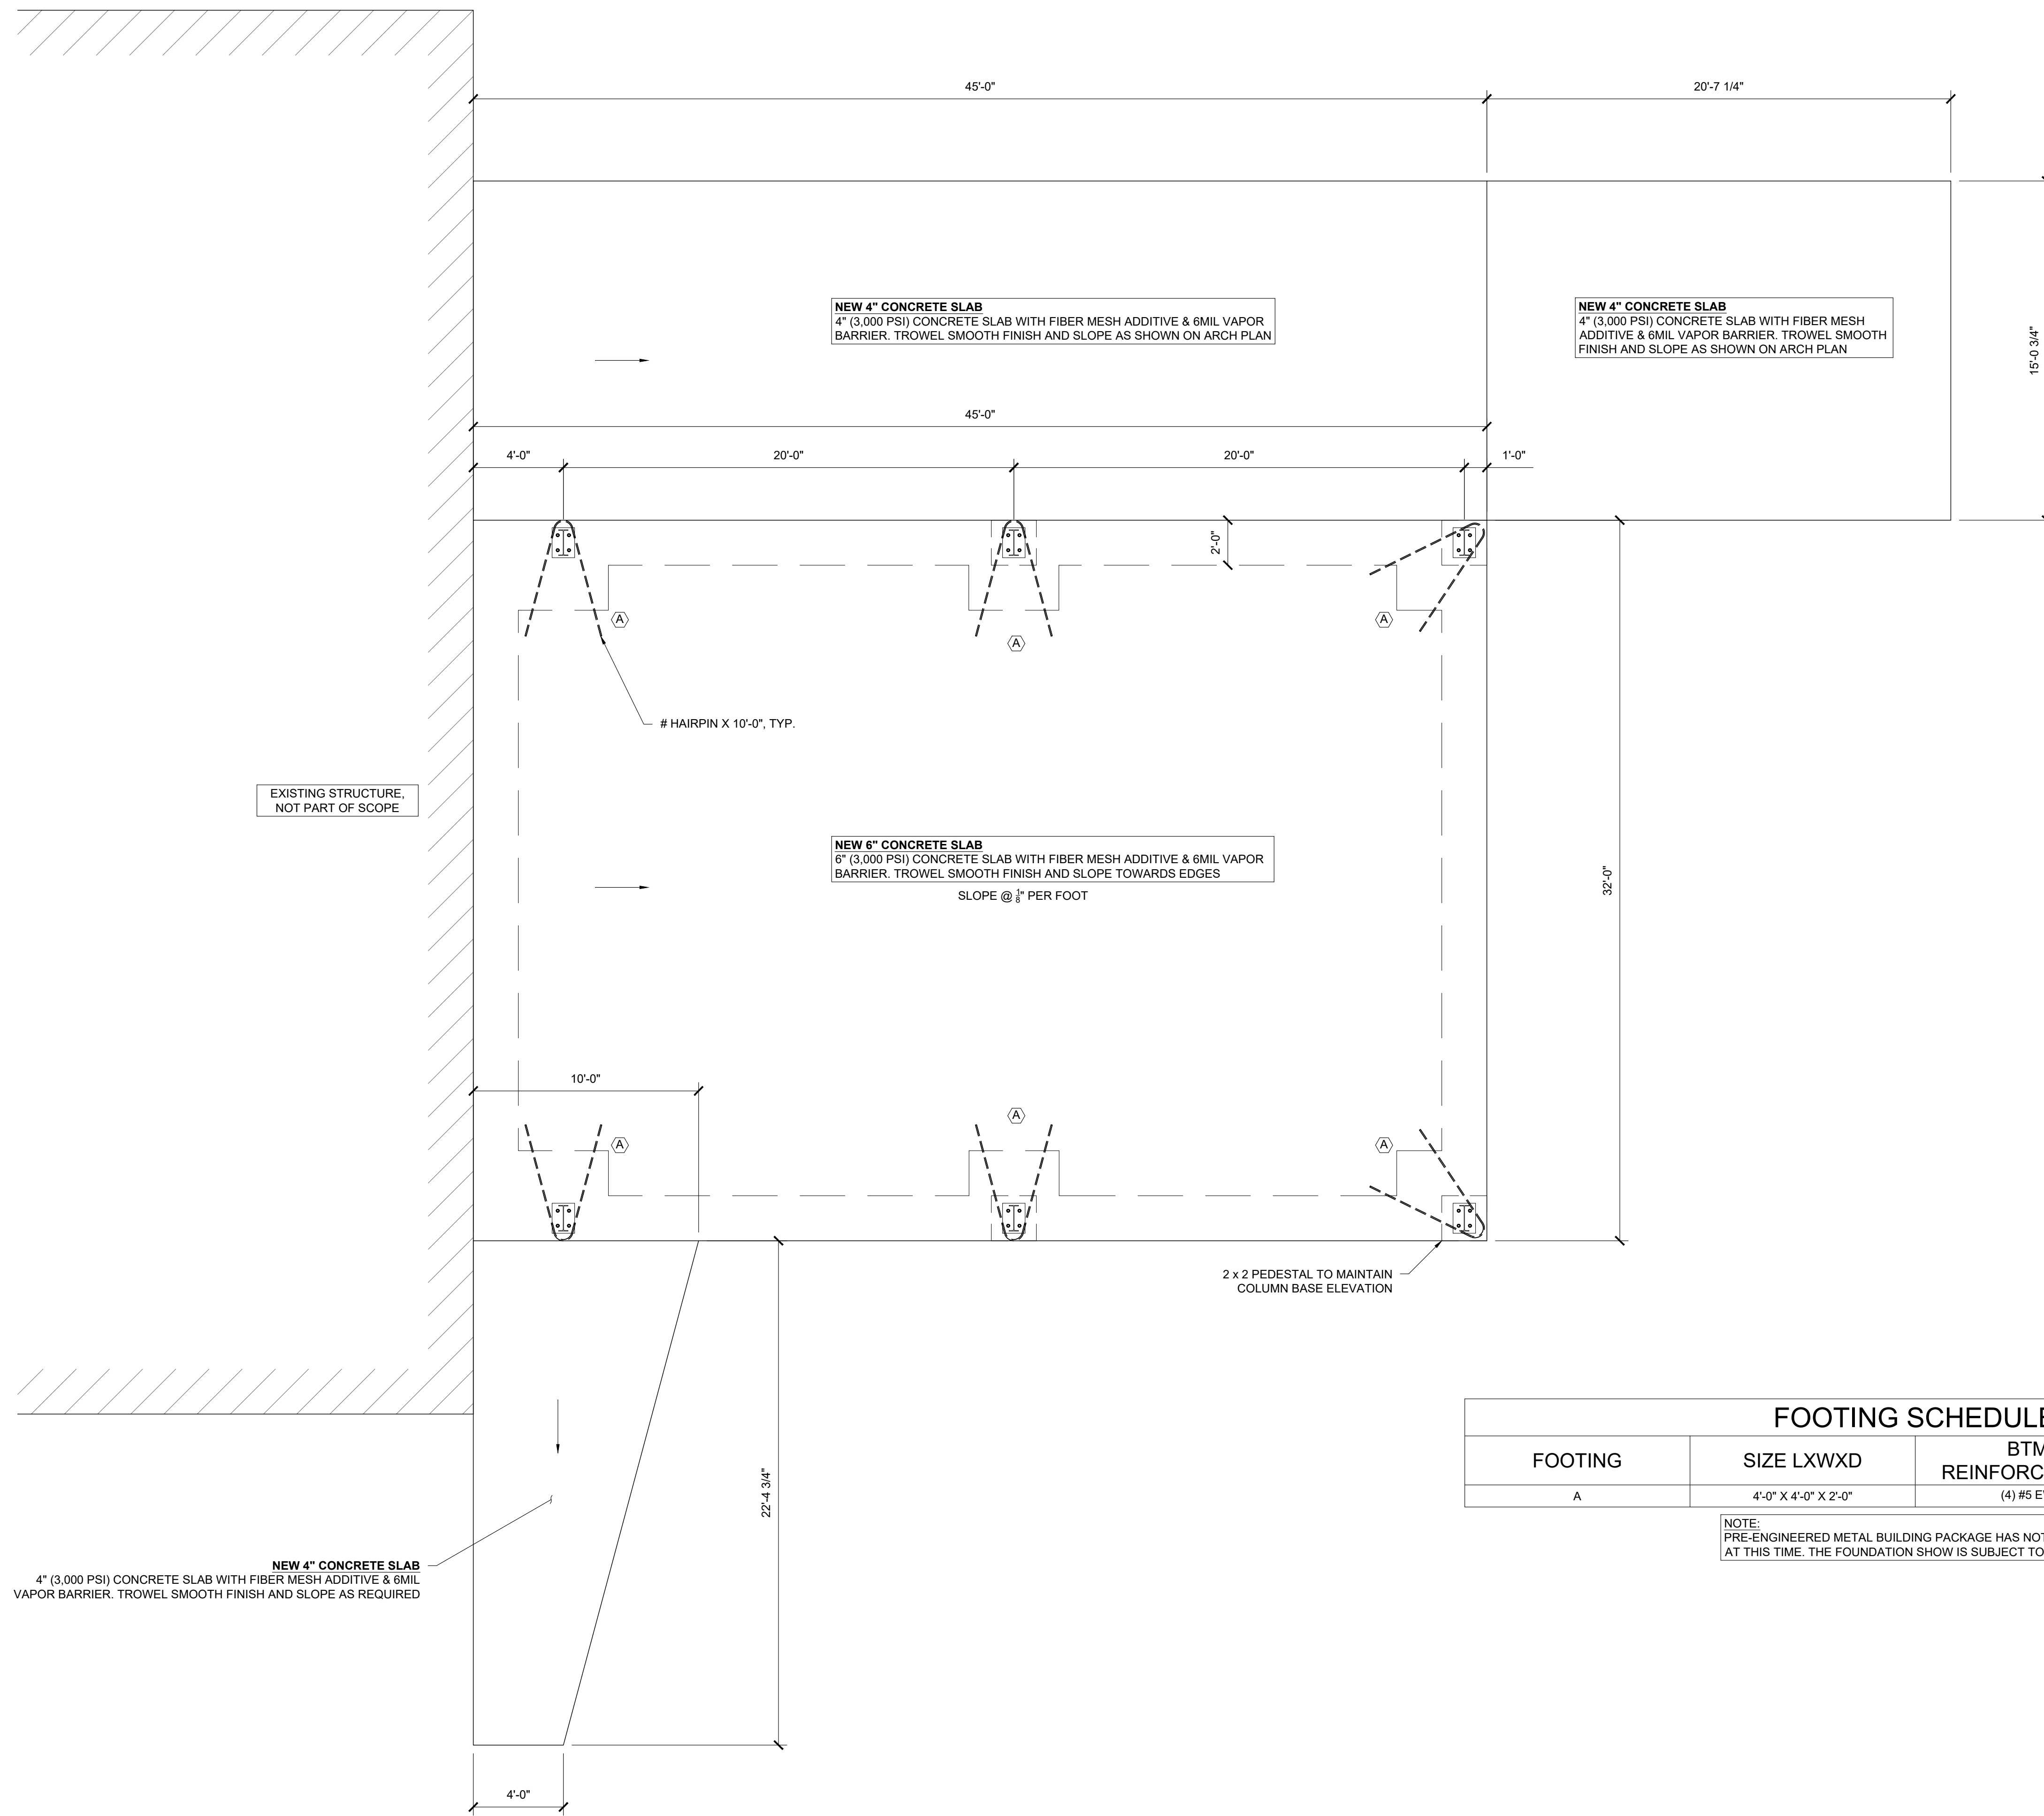
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BUILDING 500 EXTERIOR CANOPY SHELTER
HENRY GEORGETOWN TECHNICAL COLLEGE
600 SOUTH MAIN ST. SUITE 100
COLUMBIA, SC 29204
DOOR SCHEDULE & DETAILS
PREPARED FOR:
HORRY-GEORGETOWN TECHNICAL COLLEGE
101 BLDG.

PROJECT #: 241006
DATE: 05/13/2024
SCALE: AS NOTED
DESIGNED BY: SS
DRAWN BY: RP
CHECKED BY: SS

A6.01

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EXISTING STRUCTURE,
NOT PART OF SCOPE

NEW 4" CONCRETE SLAB
4" (3,000 PSI) CONCRETE SLAB WITH FIBER MESH ADDITIVE & 6MIL VAPOR BARRIER. TROWEL SMOOTH FINISH AND SLOPE AS SHOWN ON ARCH PLAN

NEW 4" CONCRETE SLAB
4" (3,000 PSI) CONCRETE SLAB WITH FIBER MESH ADDITIVE & 6MIL VAPOR BARRIER. TROWEL SMOOTH FINISH AND SLOPE AS SHOWN ON ARCH PLAN

NEW 6" CONCRETE SLAB
6" (3,000 PSI) CONCRETE SLAB WITH FIBER MESH ADDITIVE & 6MIL VAPOR BARRIER. TROWEL SMOOTH FINISH AND SLOPE TOWARDS EDGES
SLOPE @ 1/8" PER FOOT

HAIRPIN X 10'-0", TYP.

2 x 2 PEDESTAL TO MAINTAIN
COLUMN BASE ELEVATION

NEW 4" CONCRETE SLAB
4" (3,000 PSI) CONCRETE SLAB WITH FIBER MESH ADDITIVE & 6MIL VAPOR BARRIER. TROWEL SMOOTH FINISH AND SLOPE AS REQUIRED

FOOTING SCHEDULE

FOOTING	SIZE LXWXD	BTM REINFORCEMENT	TOP REINFORCEMENT
A	4'-0" X 4'-0" X 2'-0"	(4) #5 EW	(4) #5 E/W

NOTE:
PRE-ENGINEERED METAL BUILDING PACKAGE HAS NOT BEEN REVIEWED AT THIS TIME. THE FOUNDATION SHOW IS SUBJECT TO CHANGE.

FOUNDATION PLAN
SCALE: 1/4" = 1'-0"

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843.651.7903
(FAX) 843.651.7903
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CERTIFICATE OF PROFESSIONAL ENGINEERING
STATE OF SOUTH CAROLINA
NO. 13603
REGISTERED PROFESSIONAL ENGINEER
STEVEN C. MURPHY

CERTIFICATE
THE EARTHWORKS GROUP, INC.
NO. C013833
REGISTERED PROFESSIONAL ENGINEER
STEVEN C. MURPHY

REVISION SCHEDULE

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1	5/13/2024	ISSUED FOR PERMIT	BKB
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**BUILDING 500 EXTERIOR CANOPY
SHELTER**

FOUNDATION PLAN


PREPARED FOR:
HORRY GEORGETOWN TECHNICAL COLLEGE
4003 SOUTH FRASER STREET
GEORGETOWN, SC 29440

PROJECT LOCATION:
4003 SOUTH FRASER STREET
GEORGETOWN, SC 29440


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DESIGNED BY:	BMH
DRAWN BY:	BKB
CHECKED BY:	SGS

S1.01


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1 TYPICAL CONCRETE FOOTING @ COLUMNS
SCALE: NTS

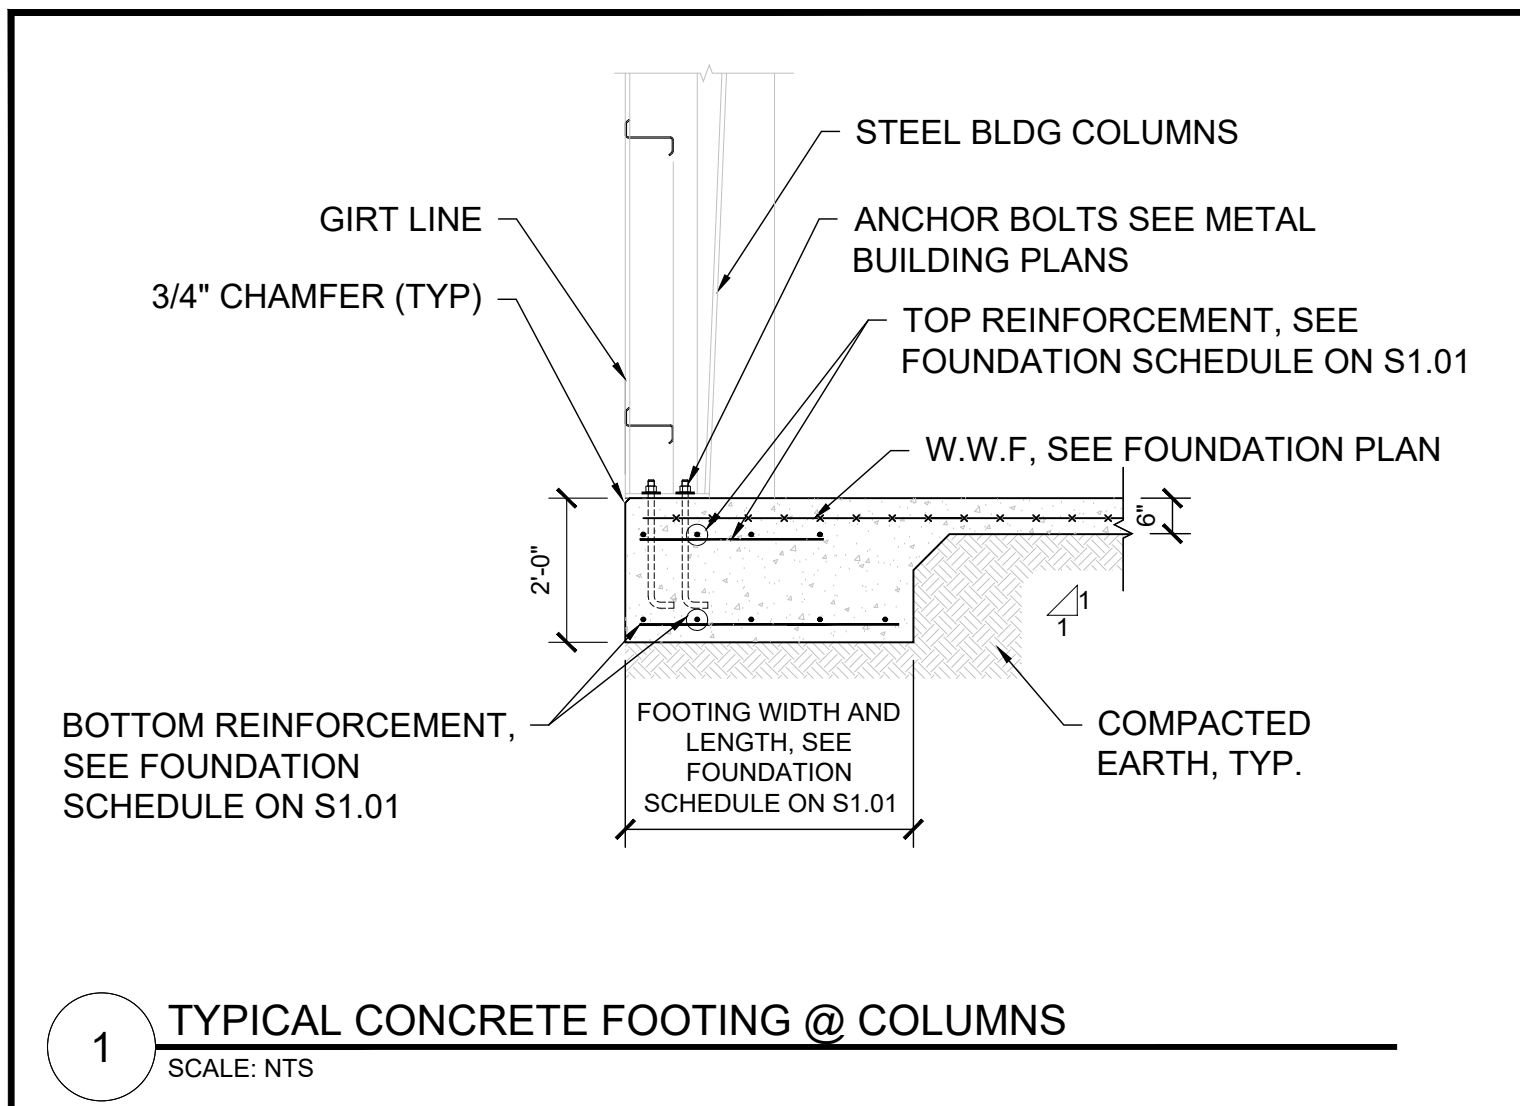

2 SECTION @ TURNDOWN
SCALE: NTS

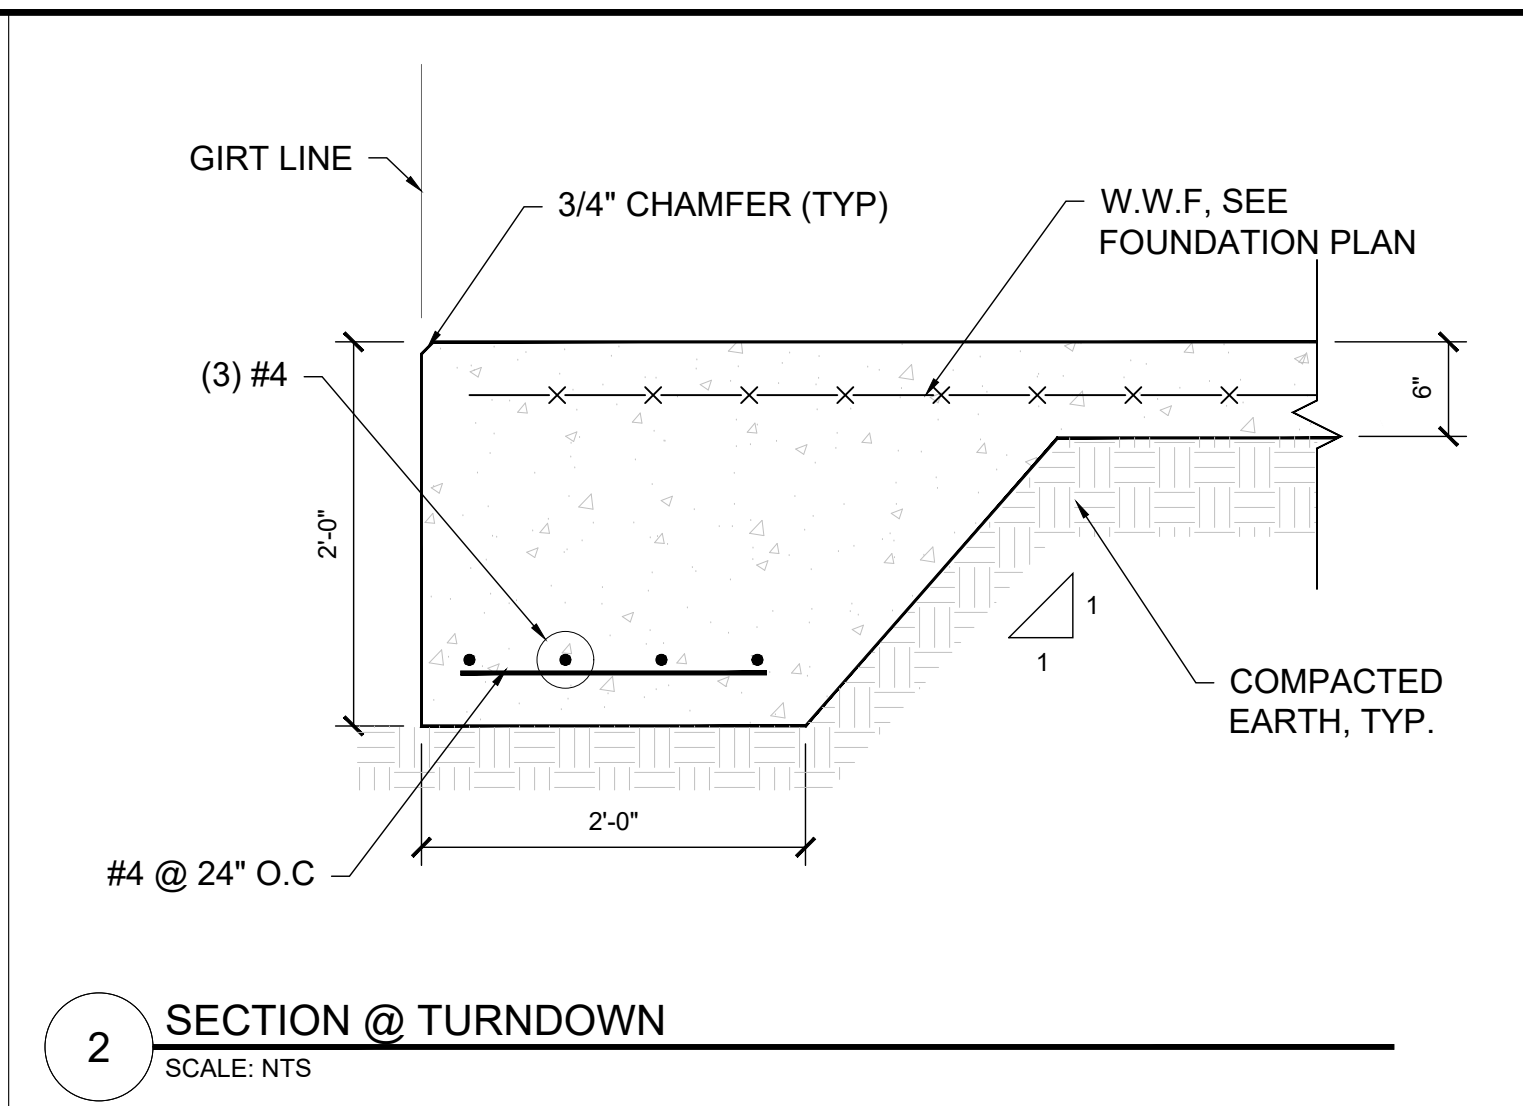



3 TYP. CONCRETE FOOTING
SCALE: NTS
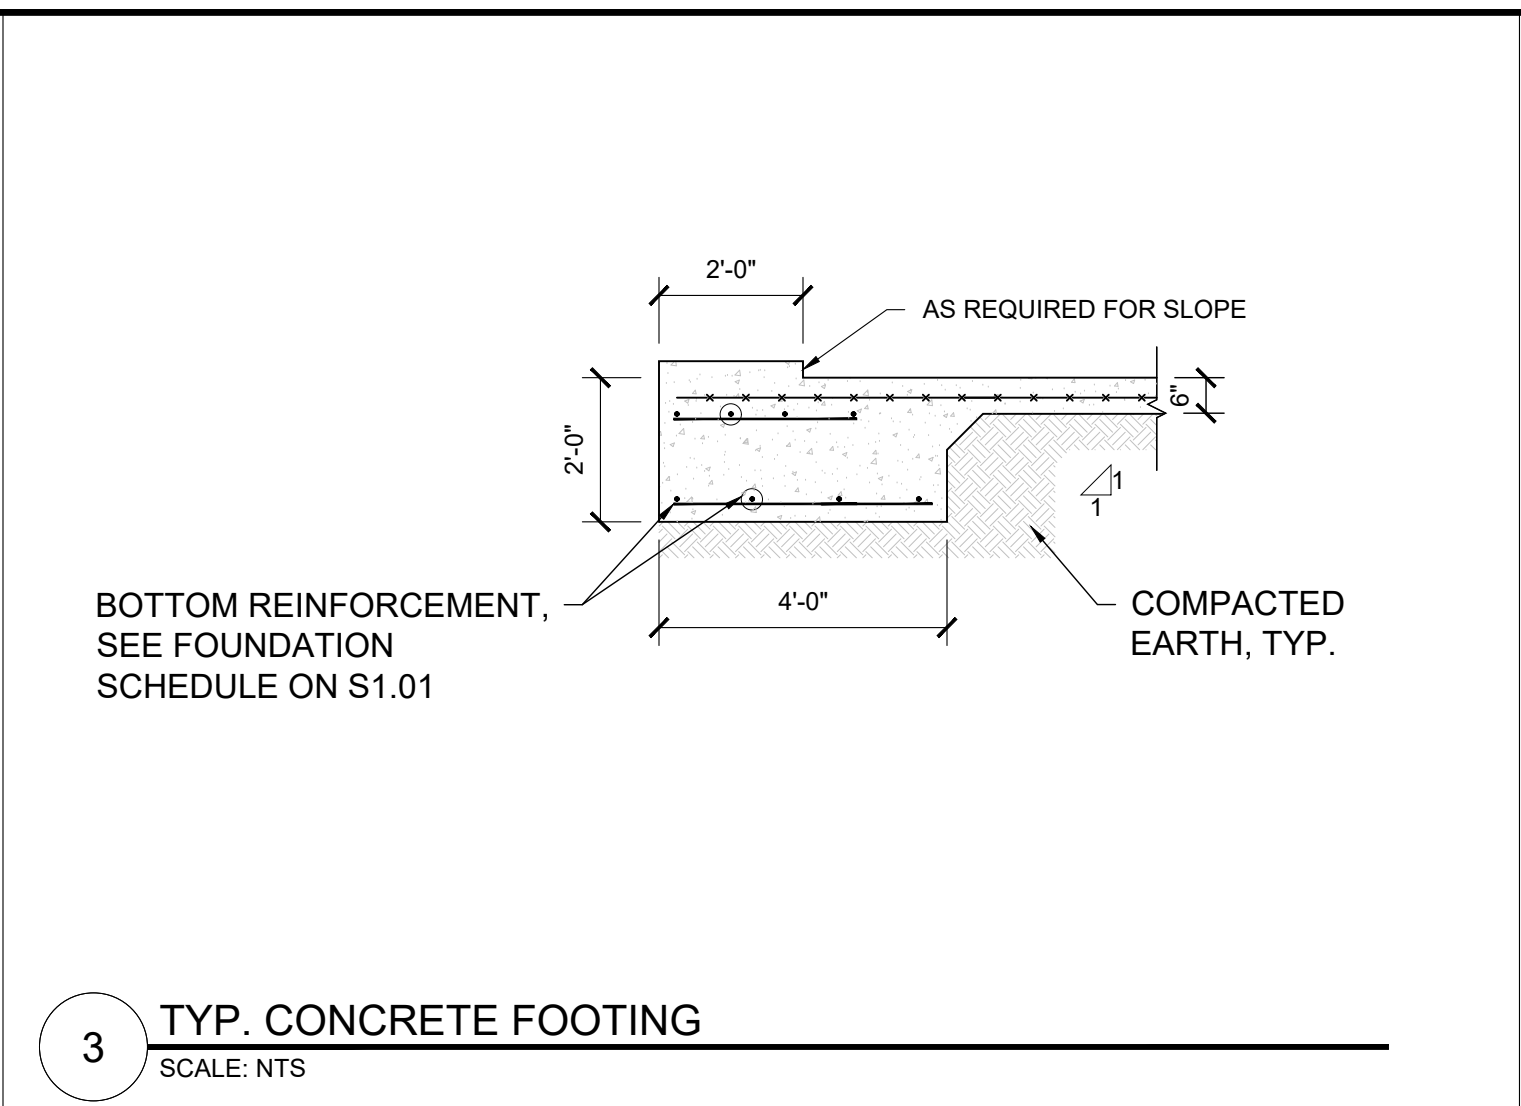
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Blank area for notes or additional specifications.

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BUILDING 500 EXTERIOR CANOPY SHELTER
STRUCTURAL DETAILS
PREPARED FOR: HOPPEY GEORGETOWN TECHNICAL COLLEGE
4003 SOUTH FRASER STREET
GEORGETOWN, SC 29440
PROJECT LOCATION: 4003 SOUTH FRASER STREET
GEORGETOWN, SC 29440

PROJECT #: 241006.000
DATE: 5/13/2024
SCALE: AS NOTED
DESIGNED BY: BMH
DRAWN BY: BKB
CHECKED BY: SGS

S2.01

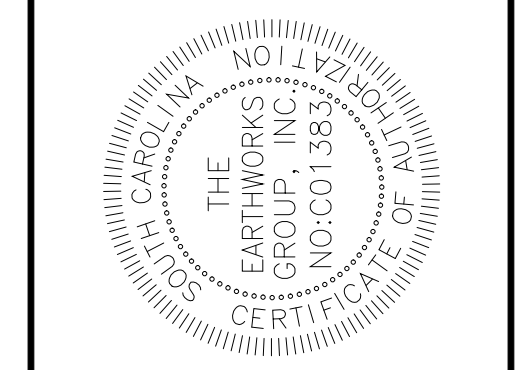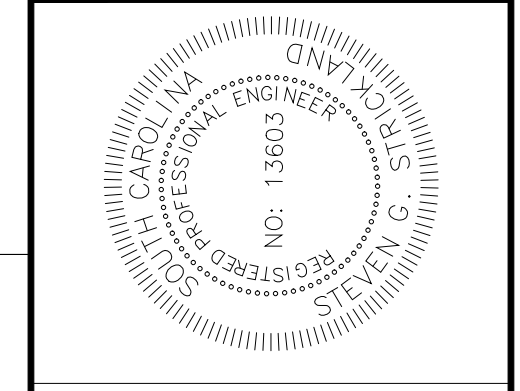2024/05/13 10:00 AM - 2024/05/13 10:00 AM
 PROJECT: 241006.000
 SHEET: S2.01
 SCALE: AS NOTED
 DATE: 5/13/2024
 BY: BKB
 CHECKED BY: SGS
 DESIGNED BY: BMH
 DRAWN BY: BKB

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